

DRAWING LIST

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GENERAL NOTES

All works shall comply with BCA Volume 2 – 2022 and the relevant Standards:

All stairs to comply with BCA Part 3.9.1

All steel framing works shall comply with BCA Part 3.4.2

All ventilation shall comply with BCA Part 3.8.5

Artificial lighting shall comply with BCA Part 3.8.4

Condensation management must comply with BCA Part 3.8.7

Earthworks to comply with BCA Part 3.1.1

Footing and Slabs to Comply with BCA Part 3.2 & AS 2870 & Structural Engineers Details

Glazing to comply with BCA Part 3.6 & AS 1288

Gutter and Downpipes to Comply with BCA Part 3.5.2 & AS/NZS 3500.3

Habitable room height must be minimum 2.4m high to comply with BCA Part 3.8.2

Handrails and balustrades to comply with BCA Part 3.9.2

Heating appliances shall comply with BCA Part 3.7.3

Masonry and Weatherproofing of Masonry to Comply with BCA Part 3.3 & AS 3700, AS 4773.1&2

Protection of openable windows to comply with BCA Part 3.9.2.5

Roof Claddings to comply with BCA Part 3.5.1 & AS 2049, AS 2050

Sanitary facilities shall comply with BCA Part 3.8.3

Smoke alarms to comply with BCA Part 3.7.2 & AS 3786– 2014 & Hard wiring AS 3000-2018

Stairs shall comply with BCA Part 3.9.1

Surface Water and Stormwater Drainage to comply with BCA Part 3.1.2 & AS/NZS 3500.3-2018

Termite Risk Management to comply with BCA Part 3.1.3 & AS 3660.1-2000

Timber Framing to Comply with BCA Part 3.4.0 & AS 1684

Weatherproofing of masonry shall comply with Part 3.3.4

201 OSLO ST, AUSTRAL, NSW, 2179

CONSTRUCTION OF A DOUBLE STORY CHILDCARE, FRONT FENCE AND CARPARK

LEGEND

A

Wall Type

101B

Door Type

W1

Window Type

1

A101

Building Section

1

A101

Wall Section

1

A101

Detail Number

1

A101

Building Elevation

1

A101

Interior Elevation

+2'-0"

Elevation Mark

ROOM

101

Room Name / Number

A

Column Line

CL

Centerline

3

Revision Tag

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CONSTRUCTION OF A DOUBLE STORY CHILDCARE, FRONT FENCE AND BASEMENT CARPARK

42 - 44 NORFOLK ROAD, GREENACRE, 2190, NSW

Cover Sheet

Job Number	D2024/06	Drawing Number	A00.01	Sheet scale	A1
Scale	1 : 48	Page Total	TBC	<div><div></div></div>	
Drawn By	MA	Checked By	AA		
Date	03/10/2024	Revision	A		

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Provide all labour and materials necessary for the proper installation of electrical services in accordance with the appropriate AS Rules and requirements of the Local Supply Authority. Arrange with the supply Authority for connection from supply main to meter board. Provide for the proper installation and connect electricity stove/s and hot water unit/s. Provide light and power points as indicated on drawings or as directed and in accordance with AS/NZS1680. Provide box to enclose meters in accordance with the requirements of the Authority concerned. Arrange for inbuilt wiring for telephone, television, computer and security installation as required. AS/NZS 3000 specifies the minimum requirements including safety provisions.

Natural lighting must be provided to all habitable rooms of a class 1 building by windows or roof lights or a proportional combination of both, or by light 'borrowed' from an adjoining room. Windows must have a clear aggregate light transmitting area of not less than 10% of the room floor area, and face a court or open veranda carport. If facing the boundary of an adjoining allotment, must be 900mm min. from that boundary. Roof lights must have a clear aggregate area of not less than 3% of the floor area of the room and face the sky. 'Borrowed' light can be supplied by a clear glazed panel or opening that is not less than 1.0% of the floor area of a room supplying the light if that room complies with the natural light requirements. Artificial lighting of one light fitting per 16 sq. metres of floor area must be provided to sanitary compartments, bathrooms, airlocks, showers etc. if natural lighting cannot be supplied

Fire/smoke detectors selected by the owner and complying with the requirements of the Local Government Act and/or state or territory regulations must be fitted in the locations required and approved by the regulatory authority and shall be installed in accordance with AS3786.

Where lightning protection is specified by the proprietor or required under regulatory provisions it shall be installed in accordance with AS1768.

## 2.1 WEATHERBOARDS OR PROFILE SHEETING

Weatherboard or profile sheeting as approved by the leading authority shall be fixed and flashed in accordance with manufacturers instructions and to the satisfaction of the lending authority. Weatherboards with laps as specified by the relevant AS shall be hardwood; pressure treated radiated pine or slash pine, cypress pine, Baltic pine or western red cedar. The boards shall have a maximum moisture content of 15% be in long lengths with staggered end joints, securely nailed and fitted with angle stops. Western red cedar used externally shall be fixed with galvanised or cadmium plated fasteners. Boards exceeding 100mm in width shall be double fastened at all bearings. All boards shall be primed or sealed all around including rebates and ends before fixing. Where vertical boarding is used it shall be fixed to battens at not more than 600mm centres and sarking acceptable to the lending authority placed behind the battens to provide air space and fixed to the frame work with adequate provision for discharge of moisture. External boarding shall be in one length or have joints specially designed for external use.

- a) Flat Sheeting: Fibre cement sheeting shall be not less than 4.5mm thick and close jointed to full height of walling or above sill level where weatherboard dados are specified. Horizontal joints shall be flashed with 0.42mm galvanised steel turned up 13mm against stud faces and down 12mm over sheet faces, lapped 25mm at joints. Internal angles of walls shall be flashed with 38mm x 38mm x 0.42mm minimum base thickness galvanised steel angles or bitumen coated metal flashing to full height of studs and lapped 50mm at joints. All vertical and horizontal joints and angles shall be covered with timber, fibre cement mouldings as approved by the lending authority. Trimmers of not less than 75mm x 38mm timber shall be provided between ends of floor bearers to support lower edge of sheeting.
- b) Profiled sheeting and Weatherboard: As approved by the lending authority shall be fixed and flashed in accordance with the manufacturer's instructions and to the satisfaction of the lending authority.

Line all internal walls not specified as otherwise with Gypsum plaster board fixed horizontally in full length sheets, or with staggered end joints to ceiling height. Sheets to have recessed edges and of thickness as recommended by the manufacturer for the stud, batten or support spacing. Fixing is to be with galvanised clouts, manufacturer approved screws and/or approved adhesive and be strictly in accordance with manufacturers I instructions. Set all internal angles. Note: Where below 1200mm in laundry, bathroom and W.C. and at back of kitchen sink unit and below 1800mm in shower recess, only approved water repellent sheet shall be used. Note: Adhesives must not be used to fix sheets in tiled areas.

Provide all labour and materials necessary for the proper installation of electrical services in accordance with the appropriate AS Rules and requirements of the Local Supply Authority. Arrange with the supply Authority for connection from supply main to meter board. Provide for the proper installation and connect electricity stove/s and hot water unit/s. Provide light and power points as indicated on drawings or as directed and in accordance with AS/NZS1680. Provide box to enclose meters in accordance with the requirements of the Authority concerned. Arrange for inbuilt wiring for telephone, television, computer and security installation as required. AS/NZS 3000 specifies the minimum requirements including safety provisions.

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b) **Profiled sheeting and Weatherboard:** As approved by the lending authority shall be fixed and flashed in accordance with the manufacturer's instructions and to the satisfaction of the lending authority.

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Sheets shall not be less than 4.5mm thick except where tiled. Sheets to be tiled shall not be less than 6mm thick. Where flush jointing is required fibreboard sheets shall be used, fixed and jointed in accordance with manufacturer's instructions.

Provide Gypsum plaster board to all internal ceilings unless otherwise specified. Sheets to have recessed edges and to be 10mm thick when fixed to ceiling battens/joists spaced at not more than 450mm and 13mm thick for 600mm spacing. Fixing is to be with galvanised clouts and/or approved adhesive and 1s to be in accordance with manufacturers recommendations as approved. Provide selected cornices, neatly mitred, properly fixed and set at all joints in full wall lengths where practicable. Gypsum plaster board for ceilings and walls shall be as per AS2589. Sheets of different thickness may be used at other spacing where their manufacture and installation complies with the Deemed to Satisfy Provisions.

Joinery timber is to be of species seasoned and free from those defects that might affect its appearance and/or durability. All to be DAR accurately cut and fitted, properly mitred and scribed as required and securely fixed. All surfaces to be left free of mill marks or other defects, filled where necessary and ready for painting or staining. Where wood plugging is required it shall be a suitable species properly seasoned.

**BRICK BUILDINGS** - Shall be at least 100mm x 50mm solid rebated properly doweled to thresholds. Mullions shall be 75mm thick and double rebated.

INTERIOR DOORS ALL BUILDINGS, EXTERIOR DOORS TIMBER FRAMED AND BRICK VENEER-Linings shall be a minimum of 38mm thick solid rebated to all door openings. Where return plaster reveals occur linings shall be 75mm x 50mm rebated. Alternatively for internal doorways 25mm linings may be used with 12mm planted stops. In brick veneer and timber framed construction 12mm clearance shall be provided over jamb linings to external openings. Linings to openings not having doors or to have swing doors are to be 25mm thick timber securely fixed. Other proprietary linings may be approved by the owner.

Fit accurately to door frame. Hang external doors with three 88mm steel bolts and internal doors unless otherwise specified with two 88mm steel bolts. External doors shall not be less than 2040mm x 820mm x 40mm thick. Where sheeted with plywood, waterproof plywood only shall be used. All framed glazed doors (external or internal) shall be minimum of 40mm thick. Internal doors shall be minimum of 35mm thick and free of warping.

Where access and mobility requirements are to be addressed in the construction of a new building, AS1428, General Requirements for Access New Building Work contain the minimum design requirements to enable access for people with disabilities. Revision of the BCA in order to address requirements of the Disability Discrimination Act (DDA) as applies to the construction of buildings with public areas will require that the latest revision of AS1428 should be used.

## 6.1 WATER SERVICES

Where a reticulated water supply is available all work shall be carried out by a licensed water plumber. All water supply installations shall be carried out in accordance with AS3500 'National Plumbing and Drainage Code'.

Where a utility supplied reticulated recycled water supply is connected as a dual reticulation it is important that no cross connection between the potable and recycled water can occur. There must be at least one external tap for each system and the recycled water system must have lilac coloured components. Identification markings and signage shall be installed as per AS1319 and AS1345. Recycled water cannot be used for human consumption or contact, household cleaning, personal washing or irrigation where fruit and crops are eaten raw or unprocessed.

Waterproofing of wet areas shall be designed and installed in accordance with requirements and construction techniques as per AS3740 and appendix for wall/floor combinations. All waterproofing installations are to be inspected and approved prior to covering. Where waterproof membranes are used in the construction of wet area membranes shall comply with AS/NZS4858

All installations must comply with AS3500.4 Provide from H/water unit with selected tubing to points necessary. Terminate with taps selected. Provide inlet stop cock to hot water unit. Water heater selections and installations to comply with AS 1056.

Provide a drainage system from pedestal pan and from wastes of all fittings unless a grey water system is to be installed and connect to the sewer main, where shown on site plan all to be in accordance with the rules and requirements of the Authority for Water Supply and Sewerage. Provide at least one gully outside the building. The Authority Certificate to be produced at Completion of the Work.

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Provide a drainage system from all fittings and from grease trap in accordance with the requirements of the Local Authority concerned. Excavate for drains to provide even falls throughout and a minimum cover of 300mm. Lay 100mm socketed vitrified clay, P V C or HDPA pipes to take discharge from wastes of washtubs, bath, shower, washbasin and grease trap. All pipes to be completely jointed with rubber rings or solvent cement as approved. All drain lines to be laid so that water is discharged into an absorption trench provided in position shown on plan. Provide an approved grease trap with lid in position shown to take the water from kitchen sink. Top of trap to be 75mm above finished ground level or nearby concrete paving level. All drainage work from fittings to the drainage line outside the building to be in accordance with the rules and requirements of the Water Supply and Sewerage Authority. That Authority 'Special Inspection' Certificate of the work to be produced by the builder. All plumbing and drainage shall be in accordance with the Code of Practice for state or territory and regulating local government area.

For guidance on installation of ceramic tiles see recommendations as set out in AS3958 parts 1 and 2.

Cover the following wall faces with selected glazed tiles: To shower recess to a height of 1800mm. To bathroom generally to a height of 135mm. To enclosing of bath and hobs to bath recess: to a height of 1350mm. To WC to a height of one row of tiles or as directed. Above kitchen sink/s and cooking area/s allow for four rows tiles. Finish at top and salient angles with round edge tiles. Provide vent tiles and selected recess fittings. Tiles to be fixed to a backing of Fibre Cement with approved adhesive. Areas for tiles can be increased by proprietor's direction or as noted on plans. All four walls in Adaptable bath/toilet to be provided with 'Plywood Lining' for future fixing of grab rails etc.

Cover floors of bathroom, shower recess, WC and ES with selected ceramic tiles, set in cement mortar or approved adhesive and graded to give an even and adequate fall to floor waste.

All paints, stains, varnishes and water colours are to be of approved brands as selected. Materials used for priming and undercoating are to be the same brand as the finishing paints or as recommended by the manufacturers of the finishes used. All finishing colours are to be selected by the proprietor. Do all necessary stopping after the priming has been applied. Rub down all surfaces to a smooth finish prior the application of each successive coat of paint. External joinery or other exposed woodwork to have a clear plastic finish is to be treated with priming oil containing wood preservative and a water repellent.

All external woodwork to be given one coat of primer, one coat of oil based undercoat and one coat of gloss finish enamel or to be given one coat of clear primer, one coat of flat clear plastic and one coat of clear plastic.

Any pine is to be primed all round as well as on the ends. Before fixing; hardwood, cypress pine, radiated pine and Oregon are to be primed on external faces including rebates. Pressure treated Canada pine is to be primed at ends before fixing.

Eaves, gutters, downpipes, exposed service pipes and wrought iron etc. to be cleaned and primed and give one coat of gloss paint all round.

Clean and prepare all external fibre cement surfaces and finish with two coats of water based paint.

All exposed woodwork in kitchen, bathroom, laundry WC EC to be prepared primed and then given one undercoat and finished with one coat of full gloss paint or to be stained and finished with two coats of clear liquid plastic as selected.

To be given one coat of sealer and two coats of paint. The finishing coat of bathroom, laundry and kitchen ceilings to be semi-gloss (unless directed otherwise).

All rooms except bathroom, laundry and kitchen to be given one coat of sealer and two coats of water based paint. To bathroom, kitchen, WC EC and laundry where no tiled or pre surfaced material is required, walls are to be given one coat of sealer, one coat of undercoat and one coat of gloss oil paint system.

All sashes, doors, fixed lights and other glass in building shall be selected and installed by procedures as set out in AS1288 and/or AS204 7 for type, thickness and area of glass according to wind loading, human impact and other considerations for glazing in frames of timber, steel, stainless steel, aluminium and bronze according to type of frame, height of building and glazing compound and for design and glazing of unframed toughened glass assemblies. Specific attention should be made to the selection of frame materials, glazing, location in walls and orientation to the path of the sun for various climate zones. Where windows are not shaded by roof, eaves or other building projections, advice by an approved specialist or manufacturer should be sought to ensure that all installations comply with the Energy Efficiency requirements of the BCA.

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## CONSTRUCTION OF A DOUBLE STORY CHILDCARE, FRONT FENCE AND BASEMENT CARPARK

42 - 44 NORFOLK ROAD, GREENACRE, 2190, NSW

## Specifications

Job Number  
D2024/06

Scale

100

Drawn By

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Date \_\_\_\_\_

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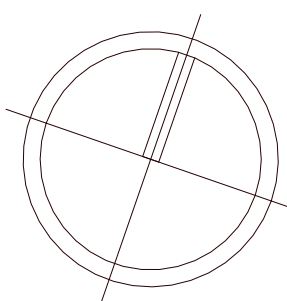
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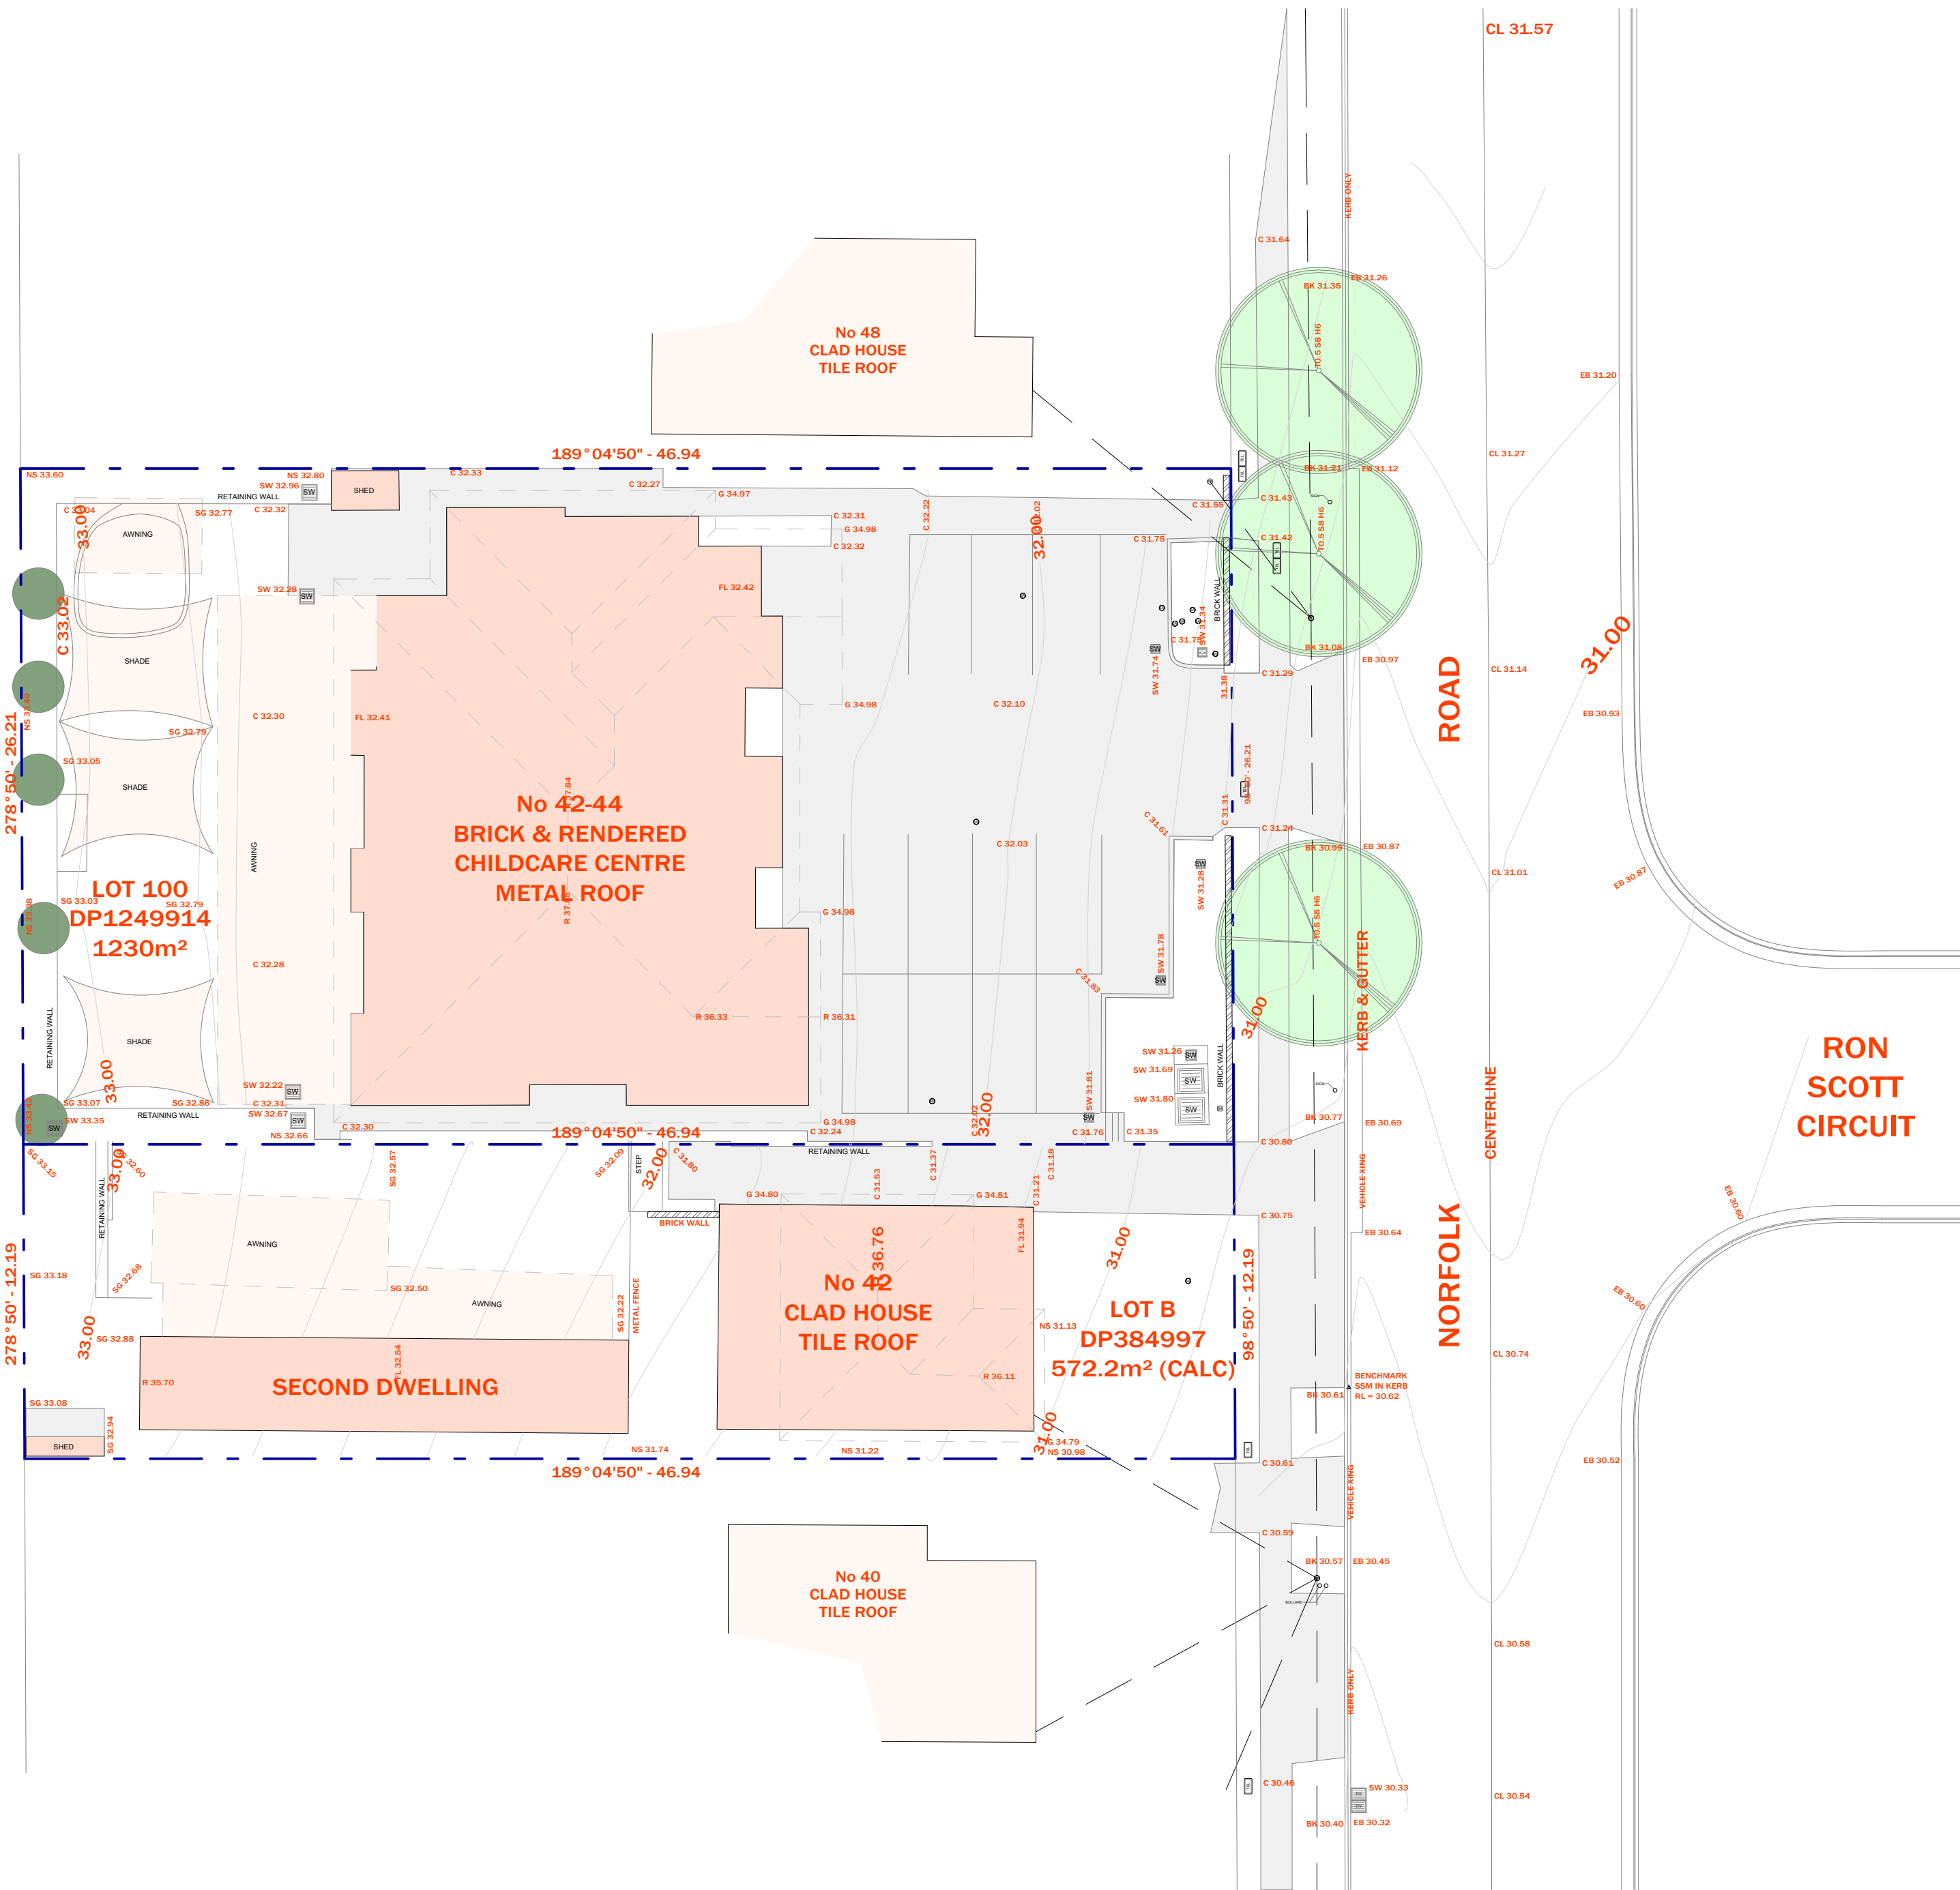
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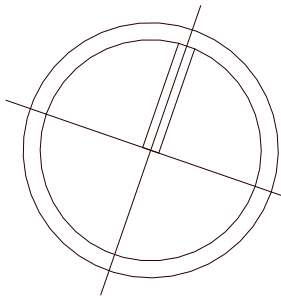
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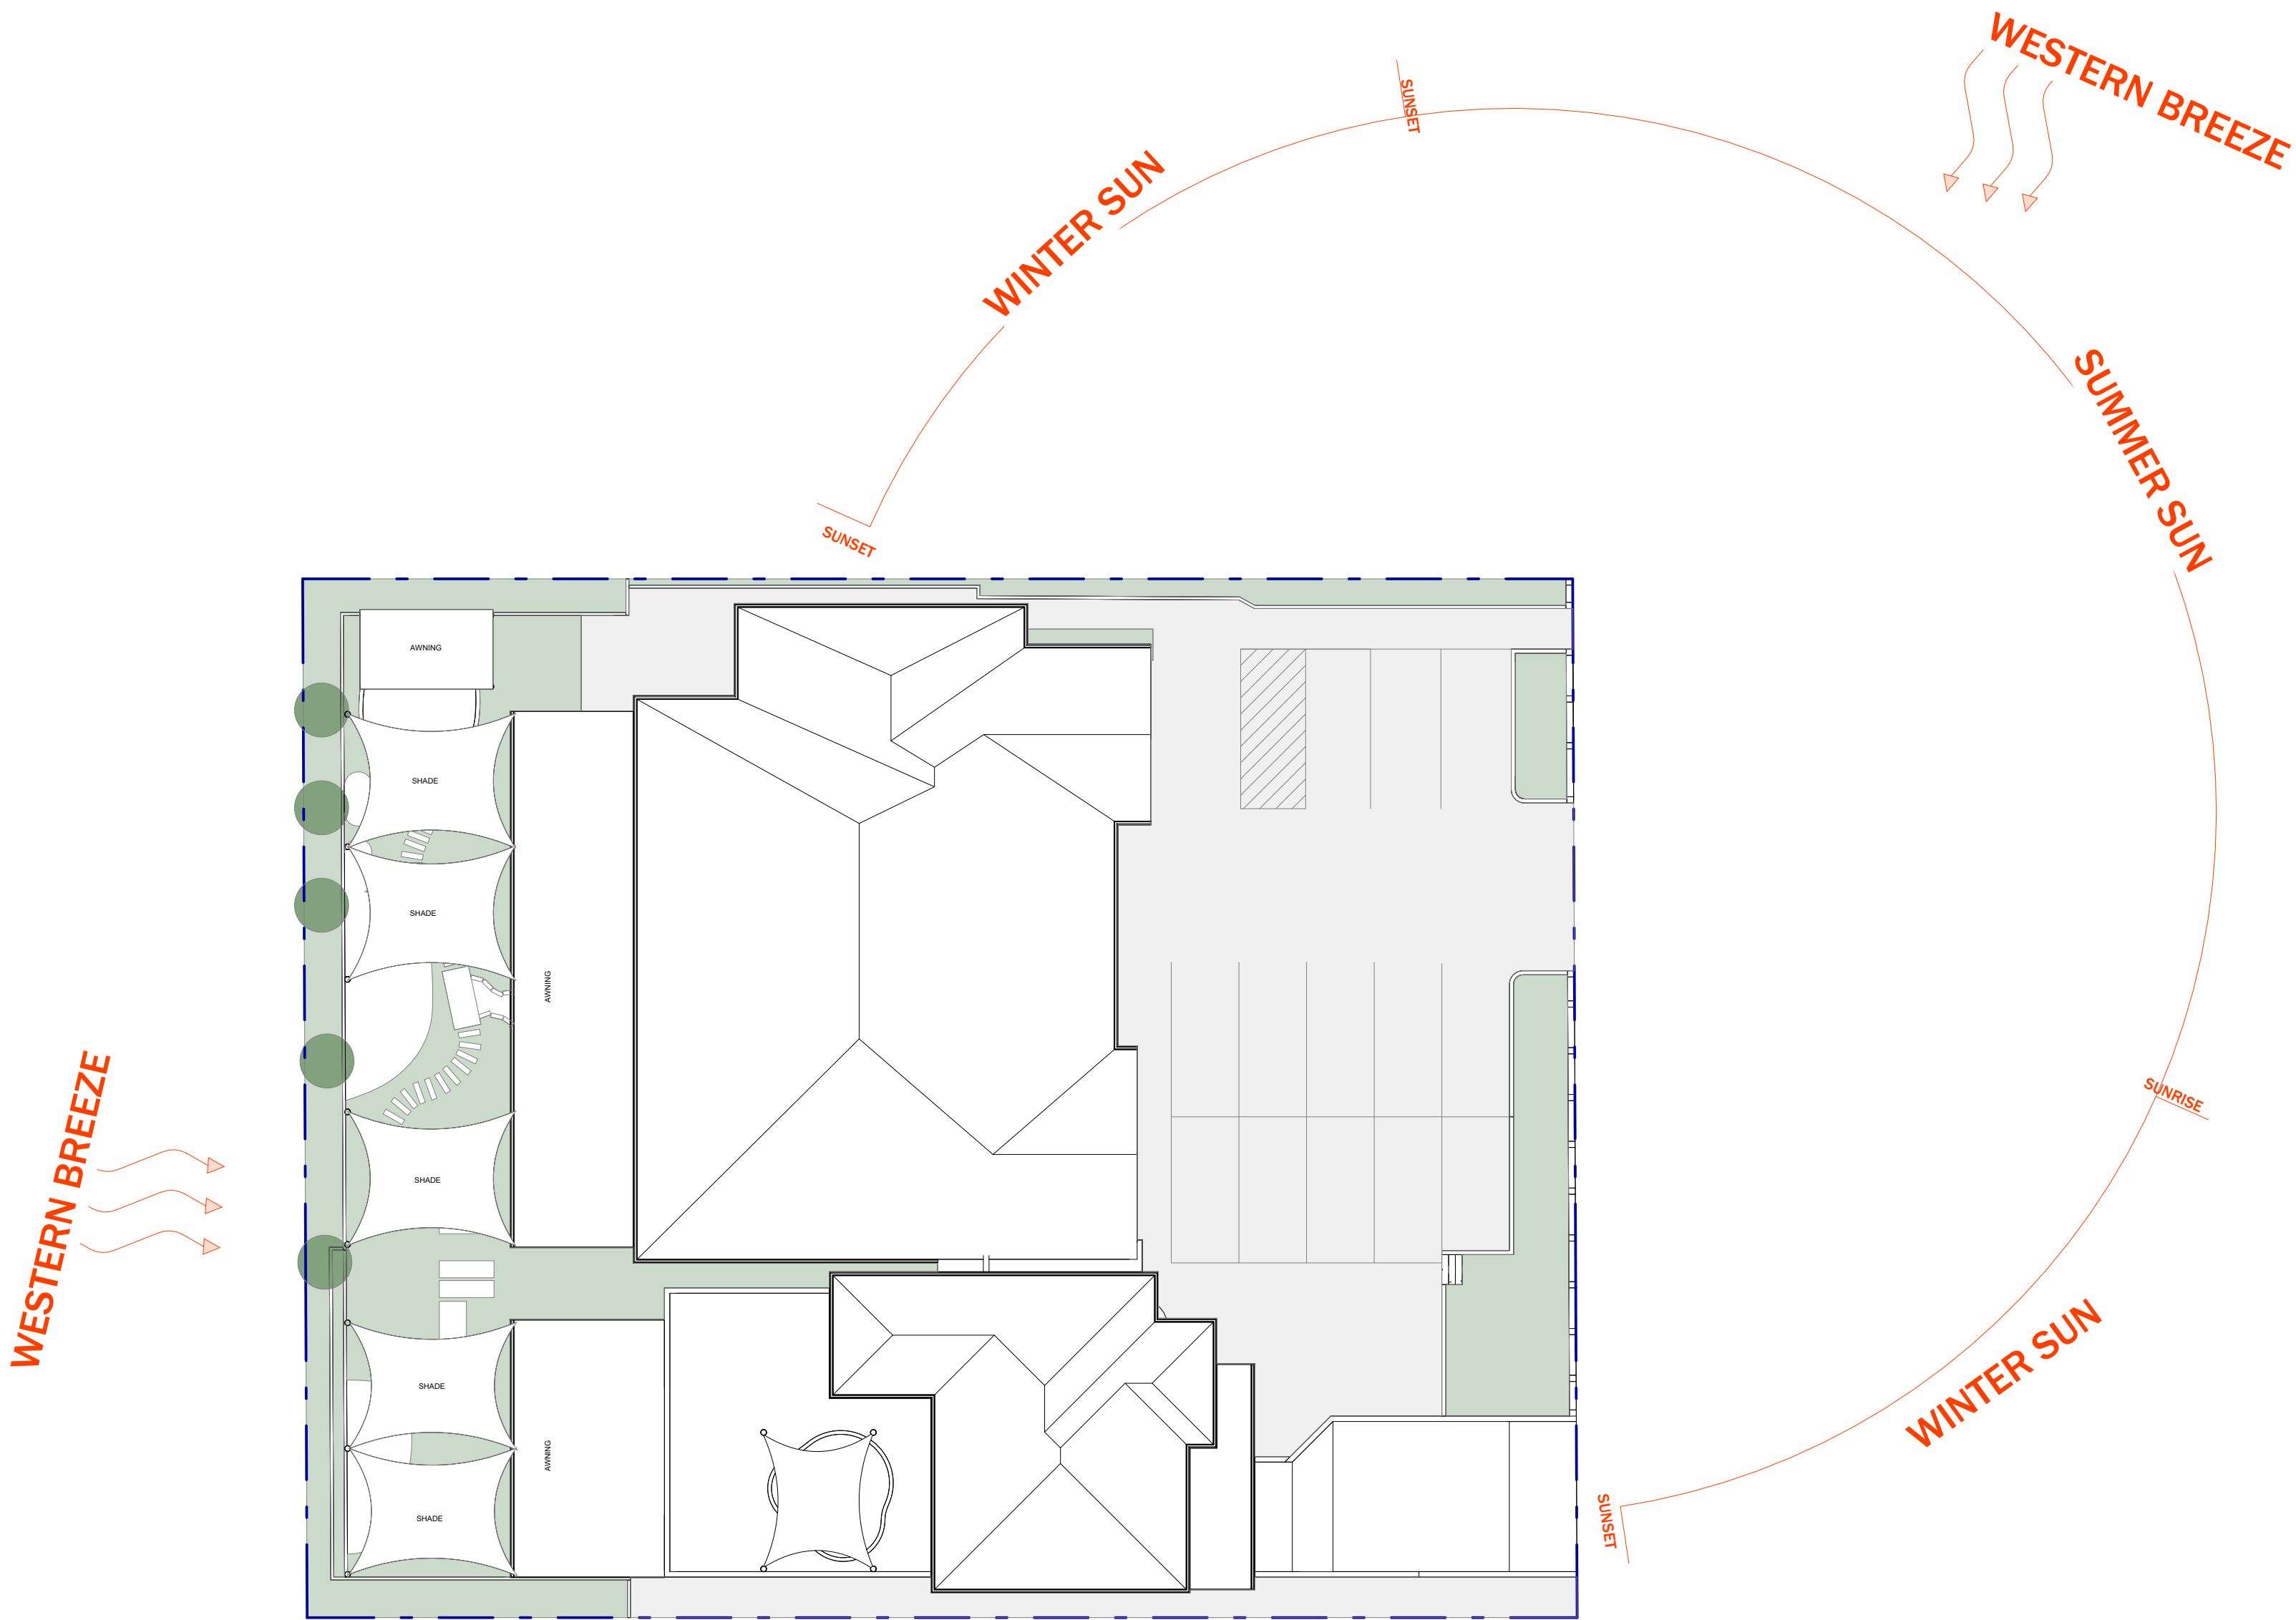
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FENCE AND BASEMENT CARPARK

42 - 44 NORFOLK ROAD, GREENACRE, 2190, NSW


Survey Plan

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LEGEND			
	SITE BOUNDARY		
	ARTICULATION ZONE		
	PROPOSED FENCE		
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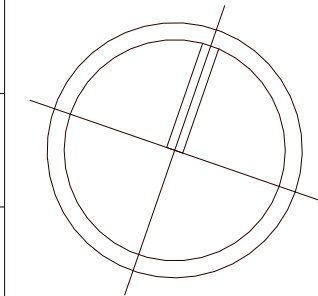
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CONSTRUCTION OF A DOUBLE STORY CHILDCARE, FRONT  
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42 - 44 NORFOLK ROAD, GREENACRE, 2190, NSW

Site Analysis Plan

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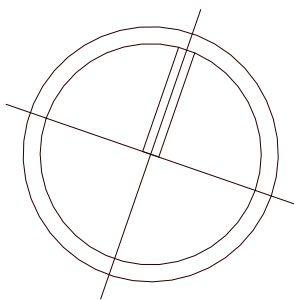
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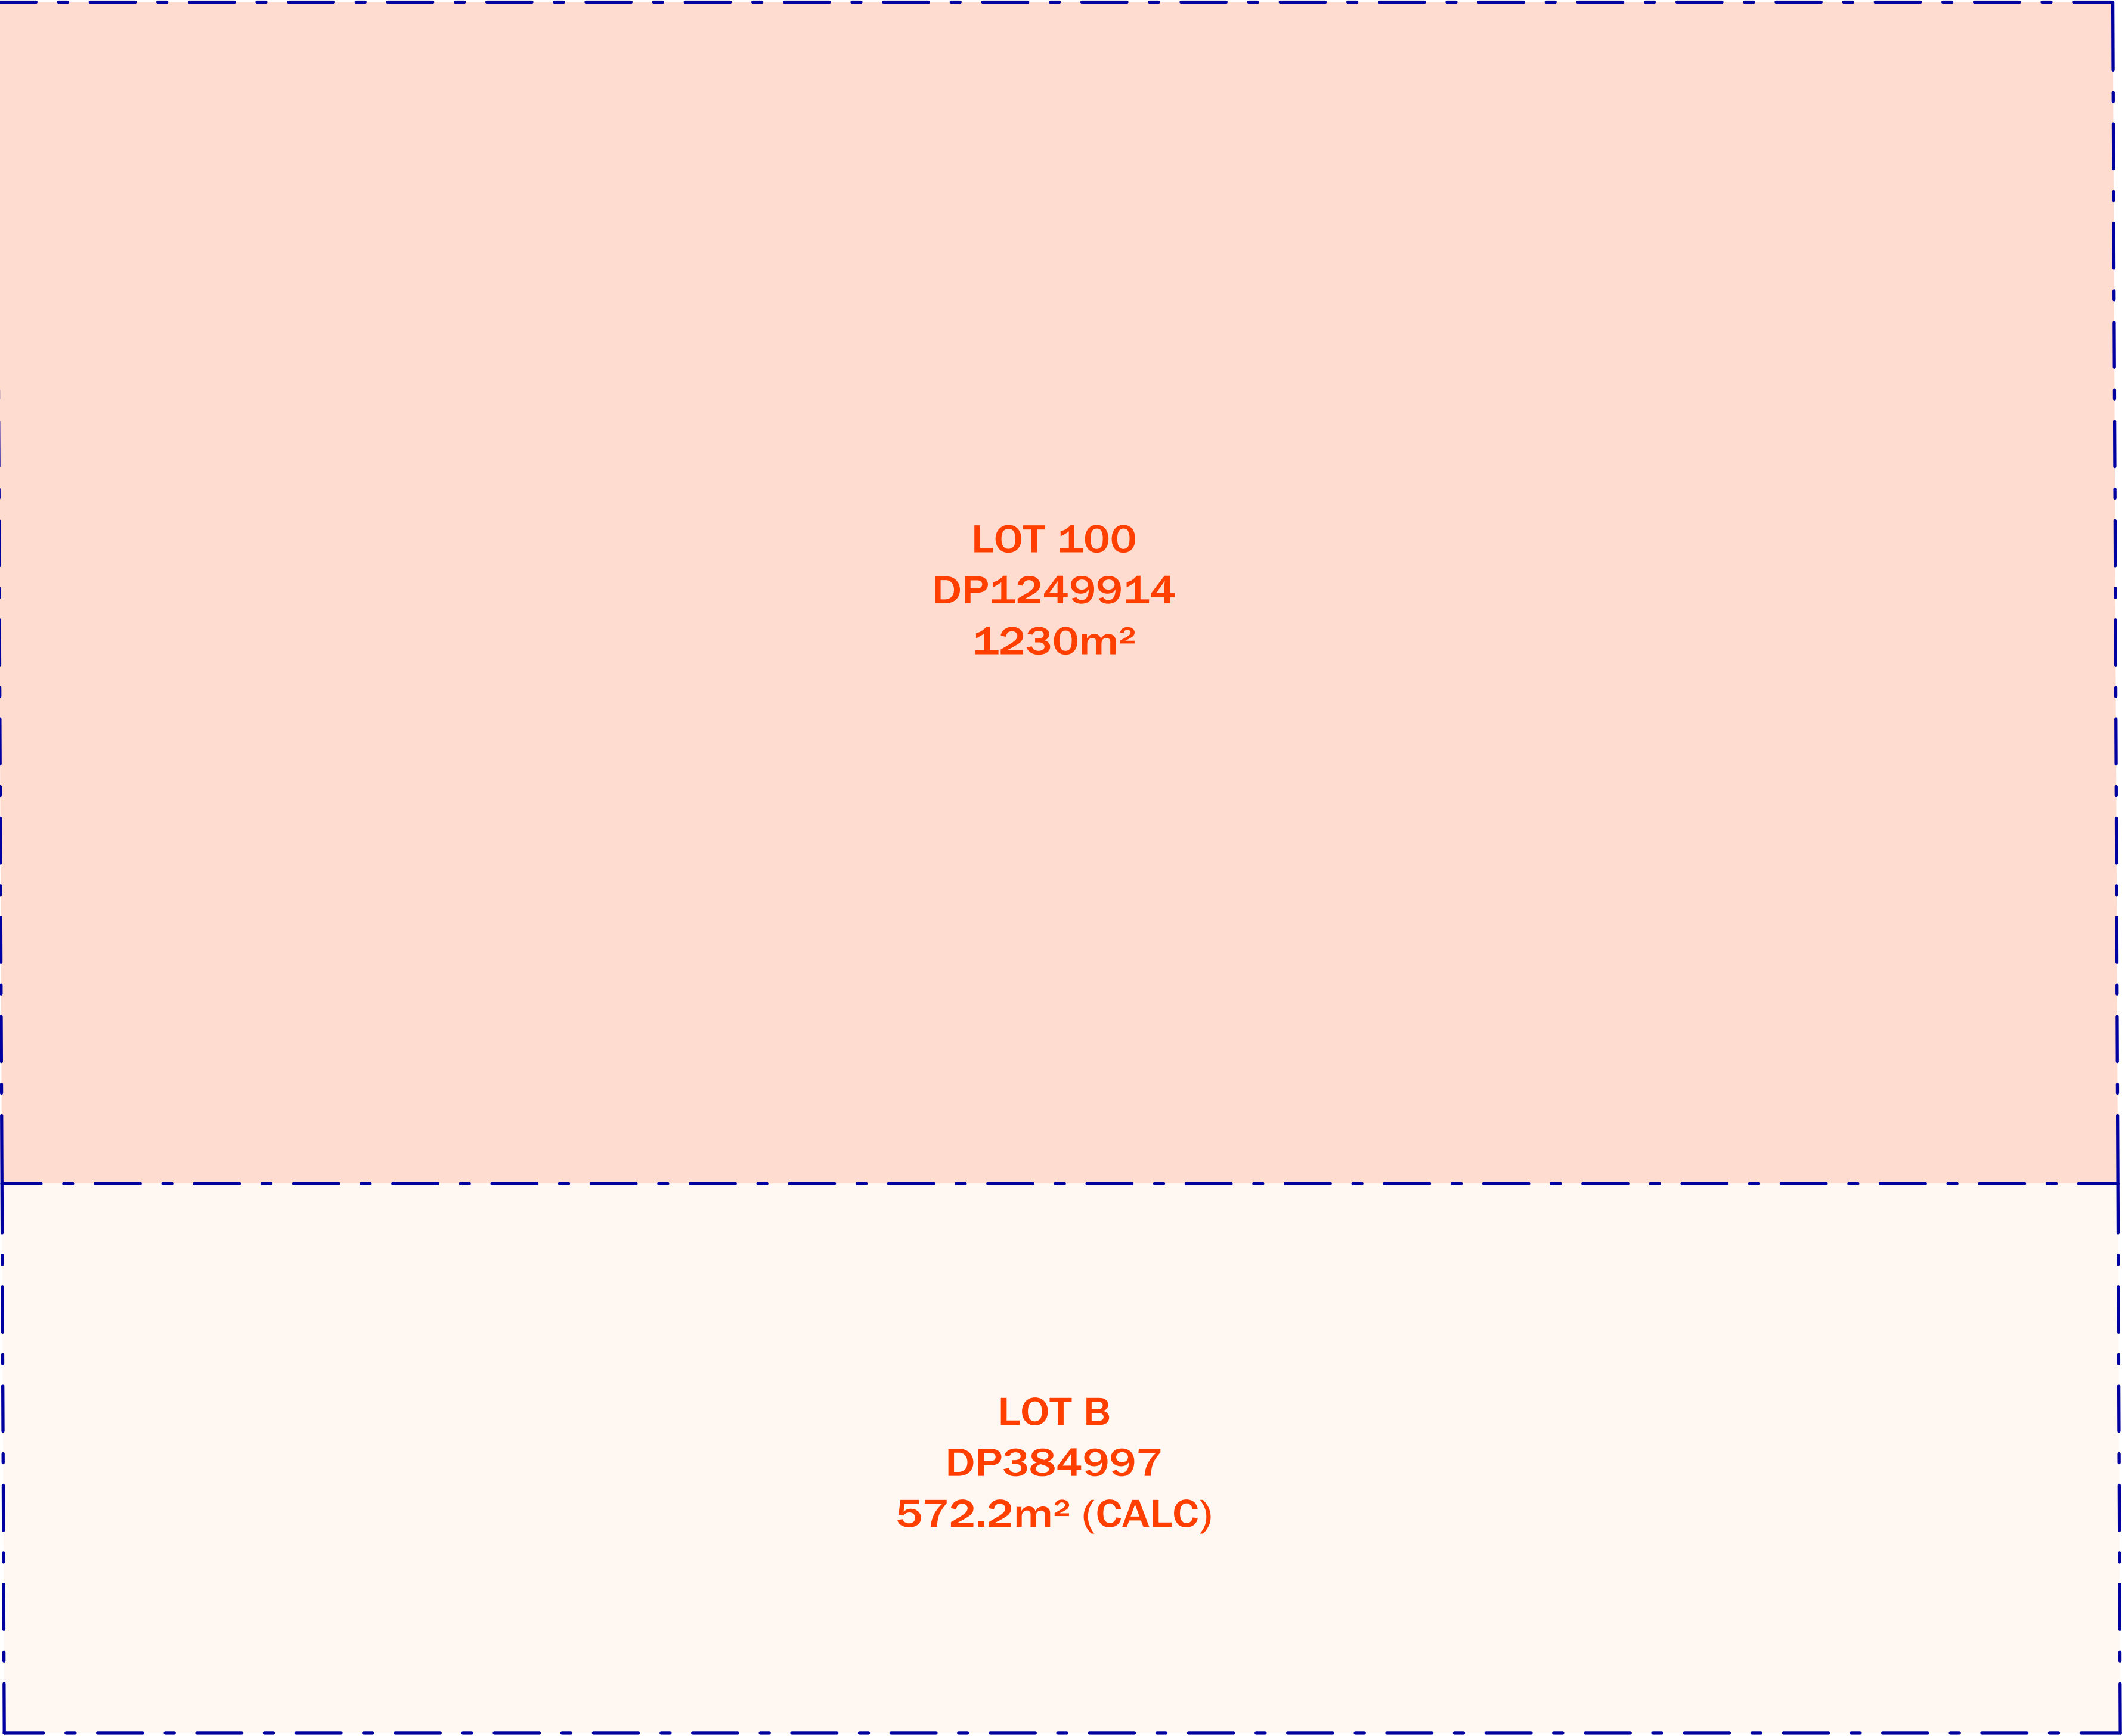
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Site Location Plan

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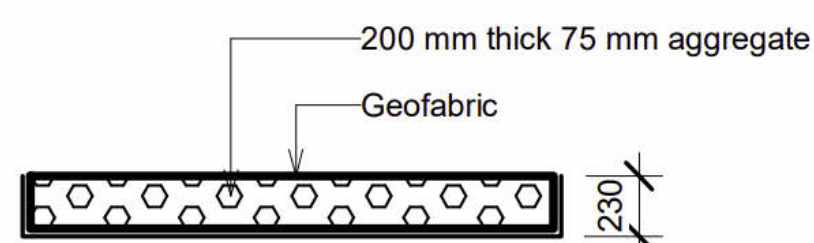
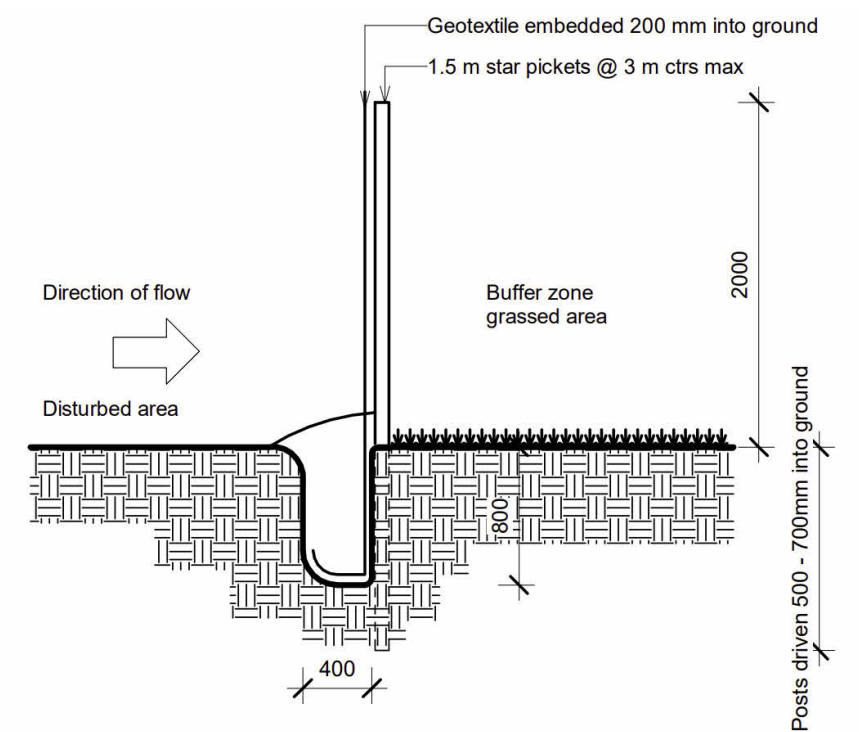




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							42 - 44 NORFOLK ROAD, GREENACRE, 2190, NSW	Scale 1 : 100	Page Total TBC	
A	03/10/2024	DA DOCUMENTATION	MA				Consolidation Plan	Drawn By MA	Checked By AA	
REV	DATE	DESCRIPTION	BY					Date 03/10/2024	Revision A	





Temporary access corridor to site for  
(movement of  
people, materials, waste and machinery)

### Stablised site access

Vehicles carrying loose building materials to be covered in compliance with road traffic regulations. Safe access for heavy equipment plant and materials delivery, sediment controls to be placed across driveway

## Material storage



Construction materials storage area  
location of stockpile material and waste. ie.  
bricks, tiles & similar materials, timber  
offcuts and recyclable materials & waste for  
landfill

**Temporary construction loading zone**

Temporary construction loading zone area  
for cranes + conc. trucks

### Site shed

Location of stockpile material and waste. ie. bricks, tiles & similar materials, timber offcuts and recyclable materials & waste for landfill top soil, sand stockpile to be covered and protected with geotextile fabric

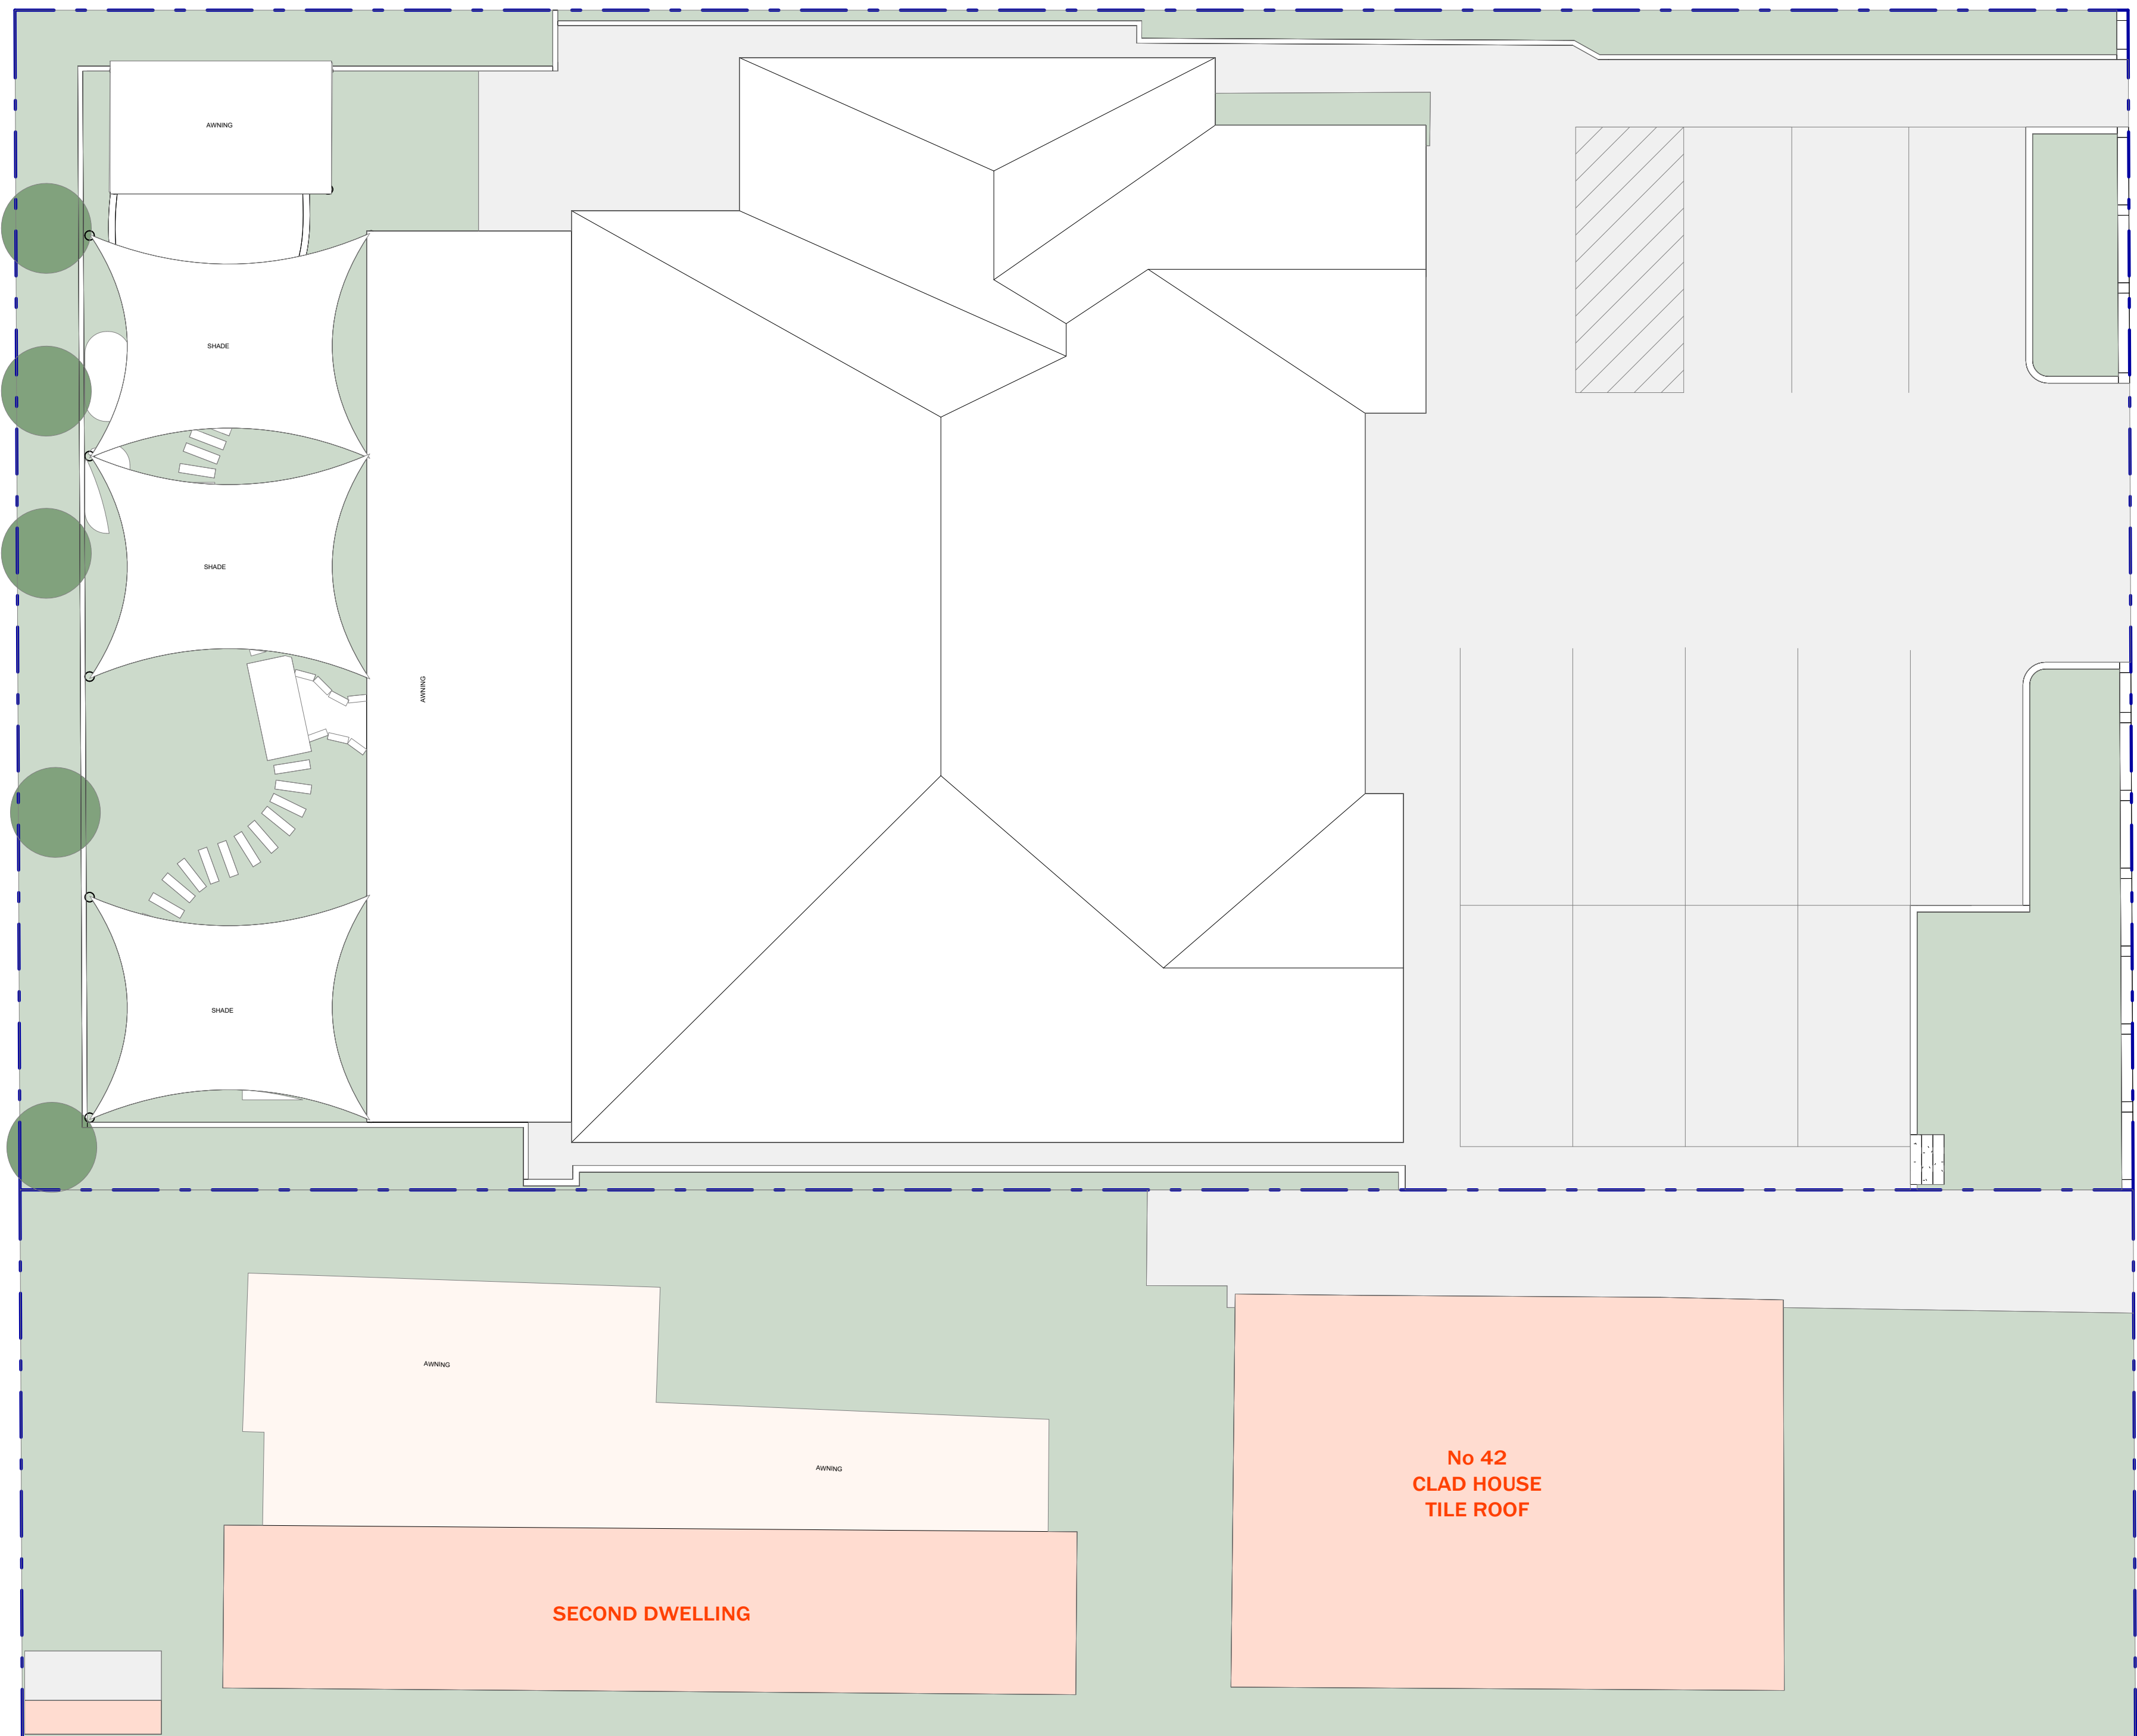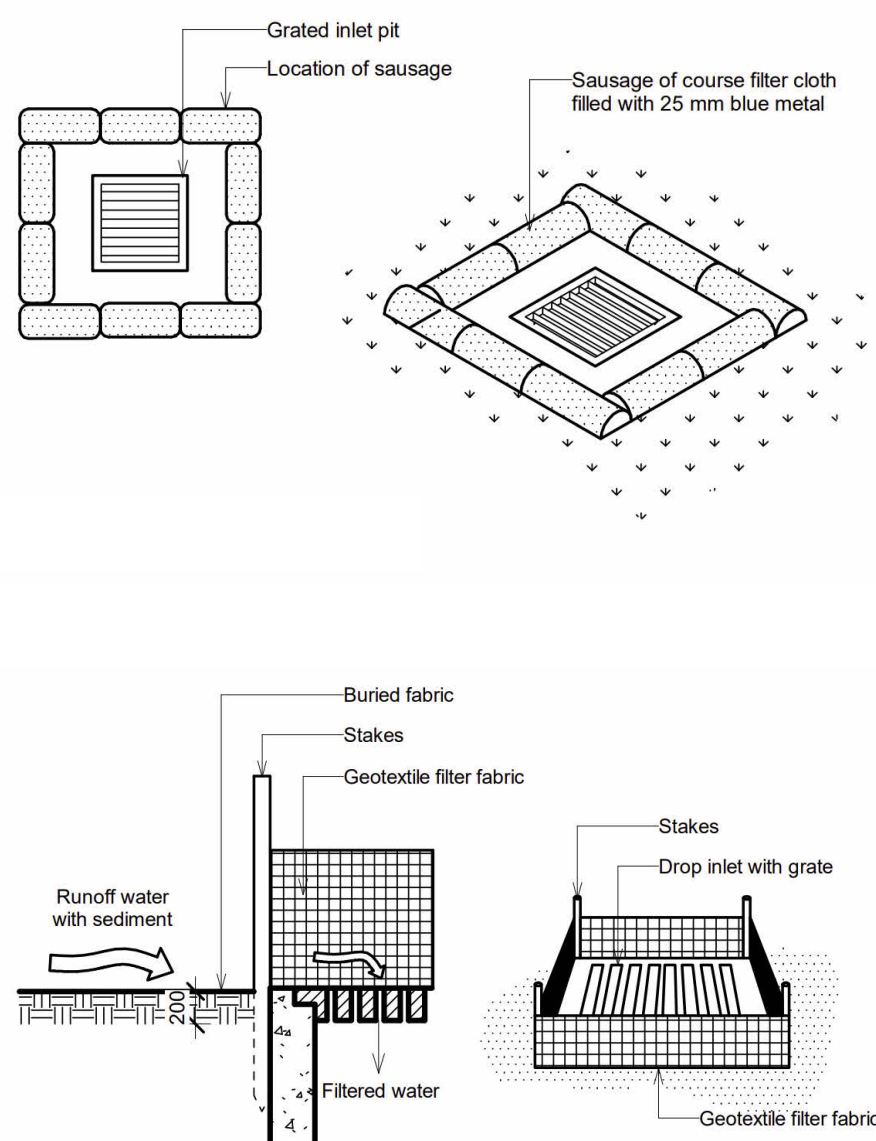

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## CONSTRUCTION OF A DOUBLE STORY CHILDCARE, FRONT FENCE AND BASEMENT CARPARK

42 - 44 NORFOLK ROAD, GREENACRE, 2190, NSW

Sedimate

Job Number	D2024/06
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Scale

As indicated

Drawn By  
MA

Date 03/10/2024

Drawing Number	A02.01
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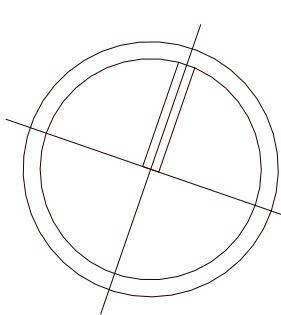
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TBC


Checked By	AA
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Revision	
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Sheet scale	A1
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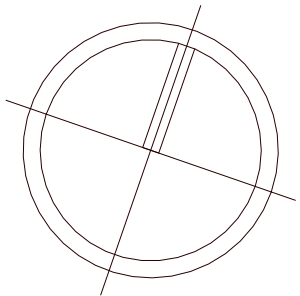
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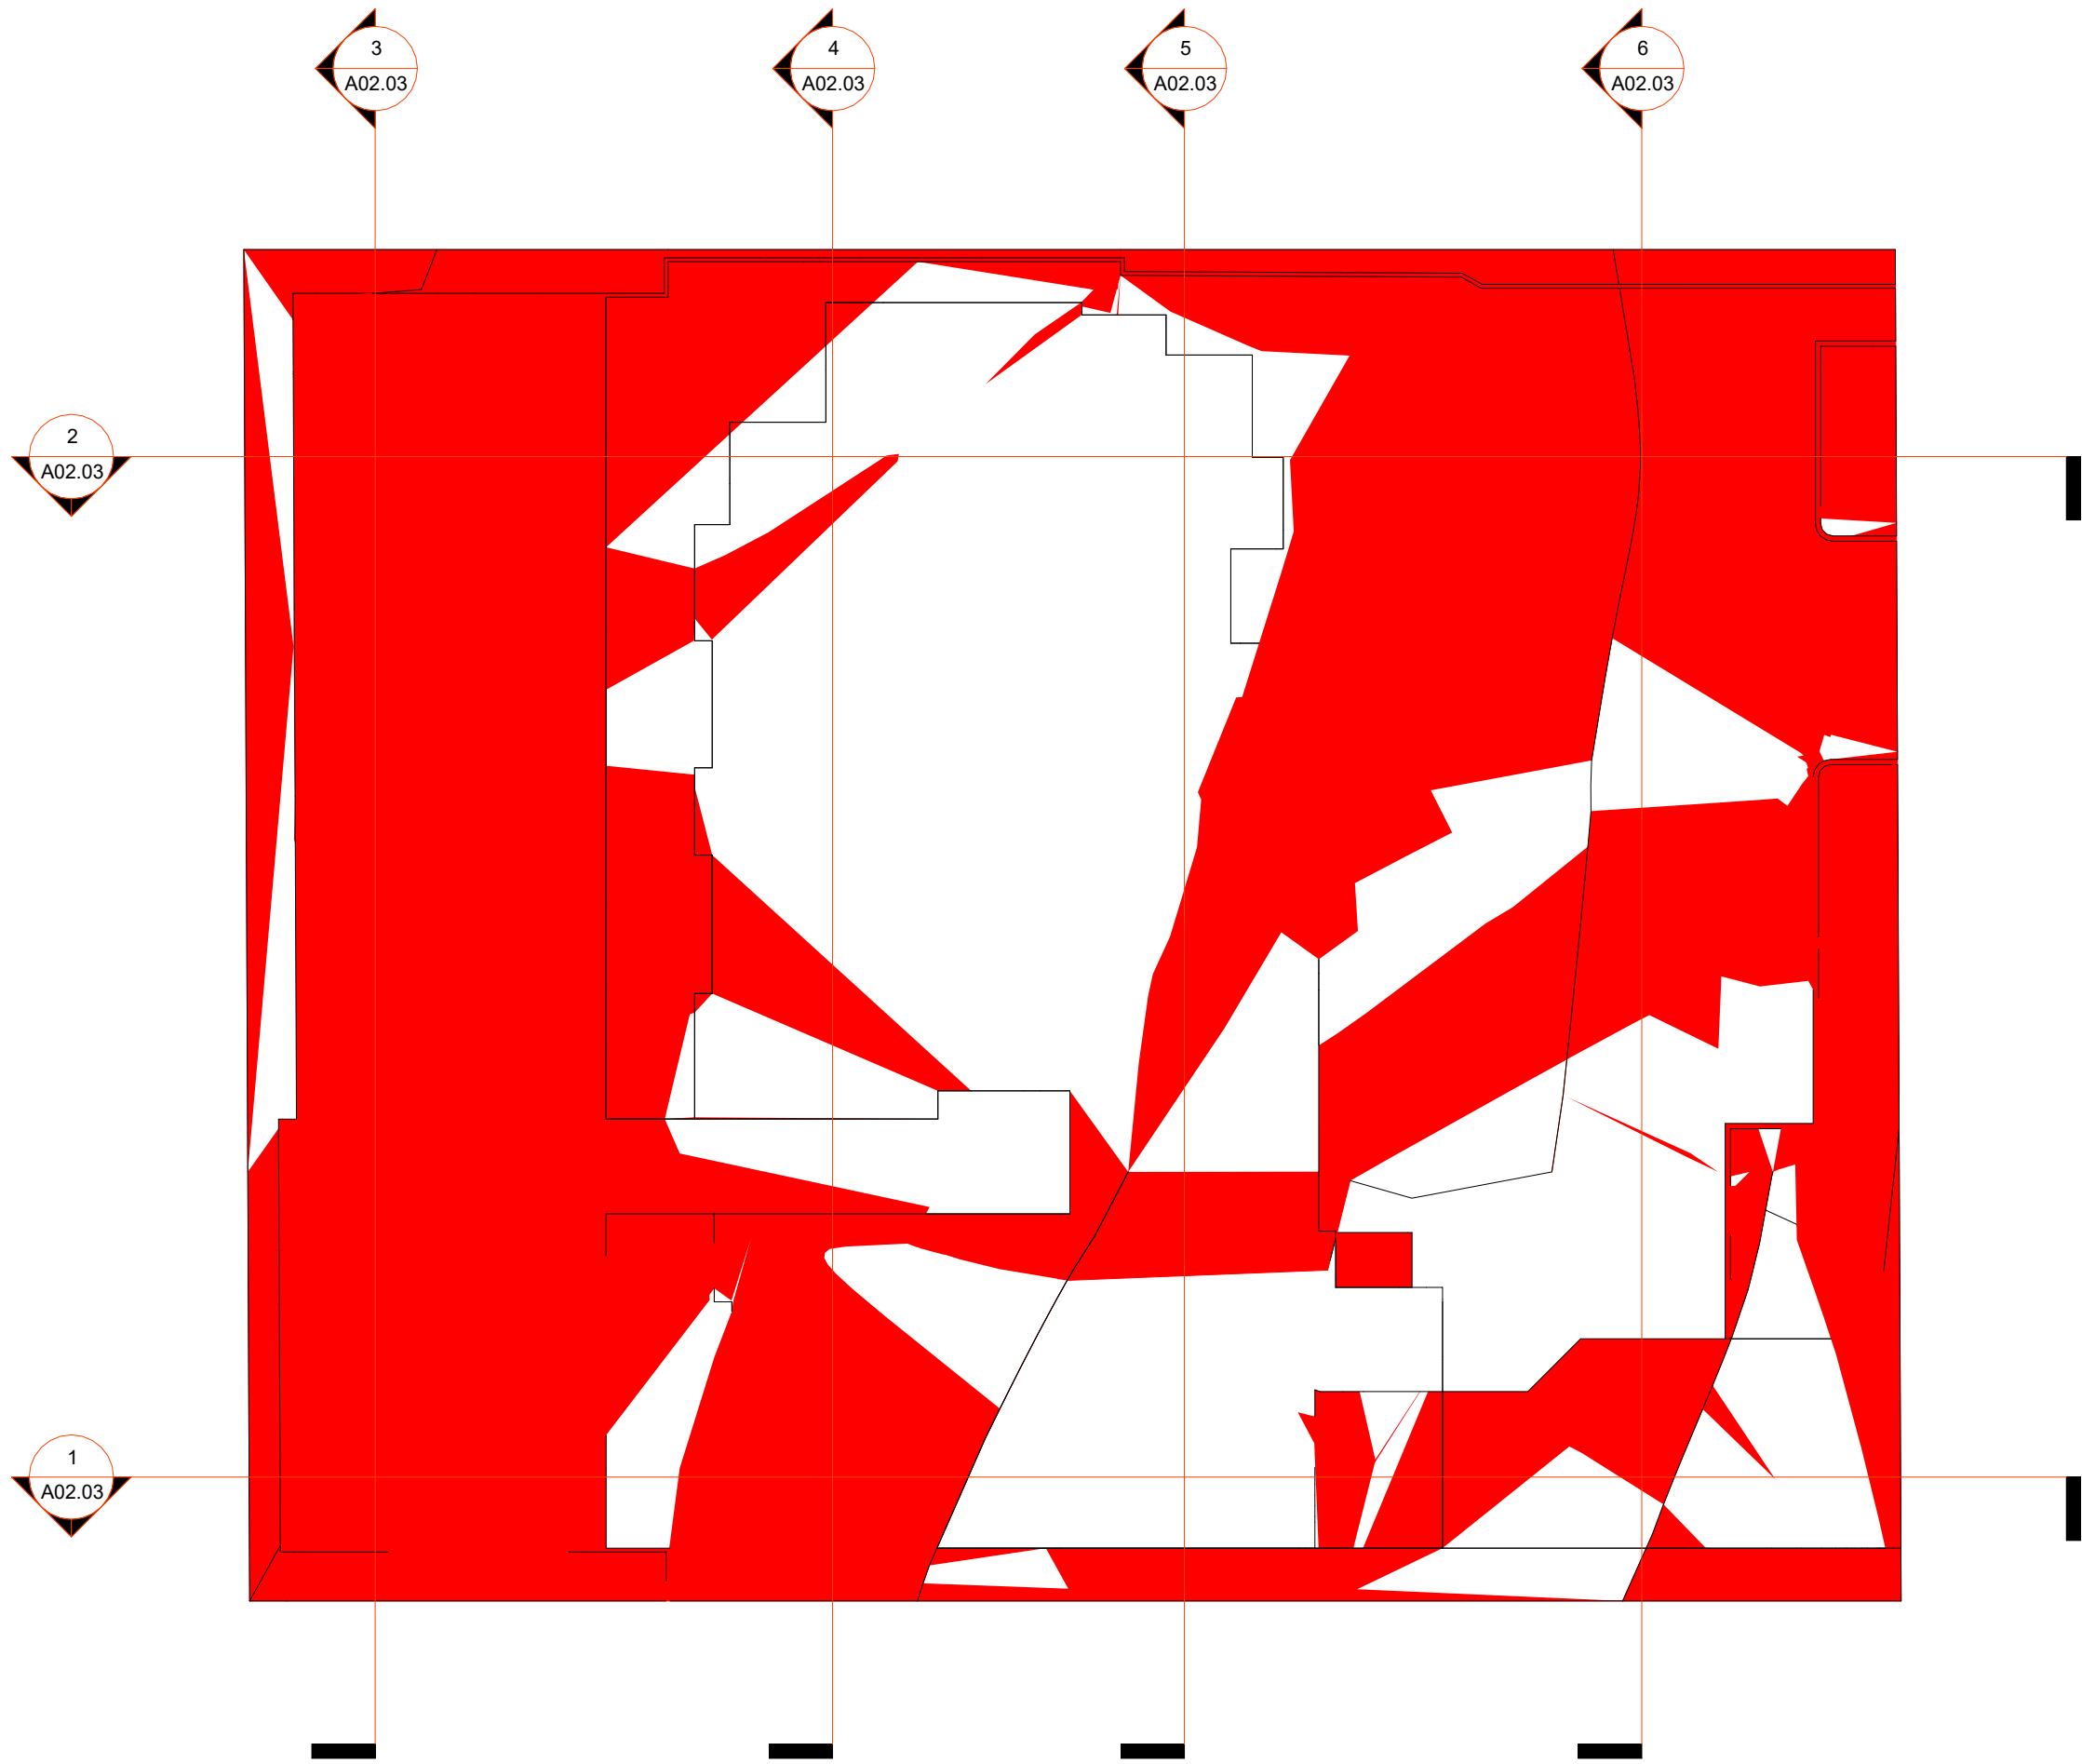
CONSTRUCTION OF A DOUBLE STORY CHILDCARE, FRONT  
FENCE AND BASEMENT CARPARK

42 - 44 NORFOLK ROAD, GREENACRE, 2190, NSW


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Job Number D2024/06	Drawing Number A02.02	Sheet scale A1
Scale 1 : 100	Page Total TBC	
Drawn By MA	Checked By AA	
Date 03/10/2024	Revision A	




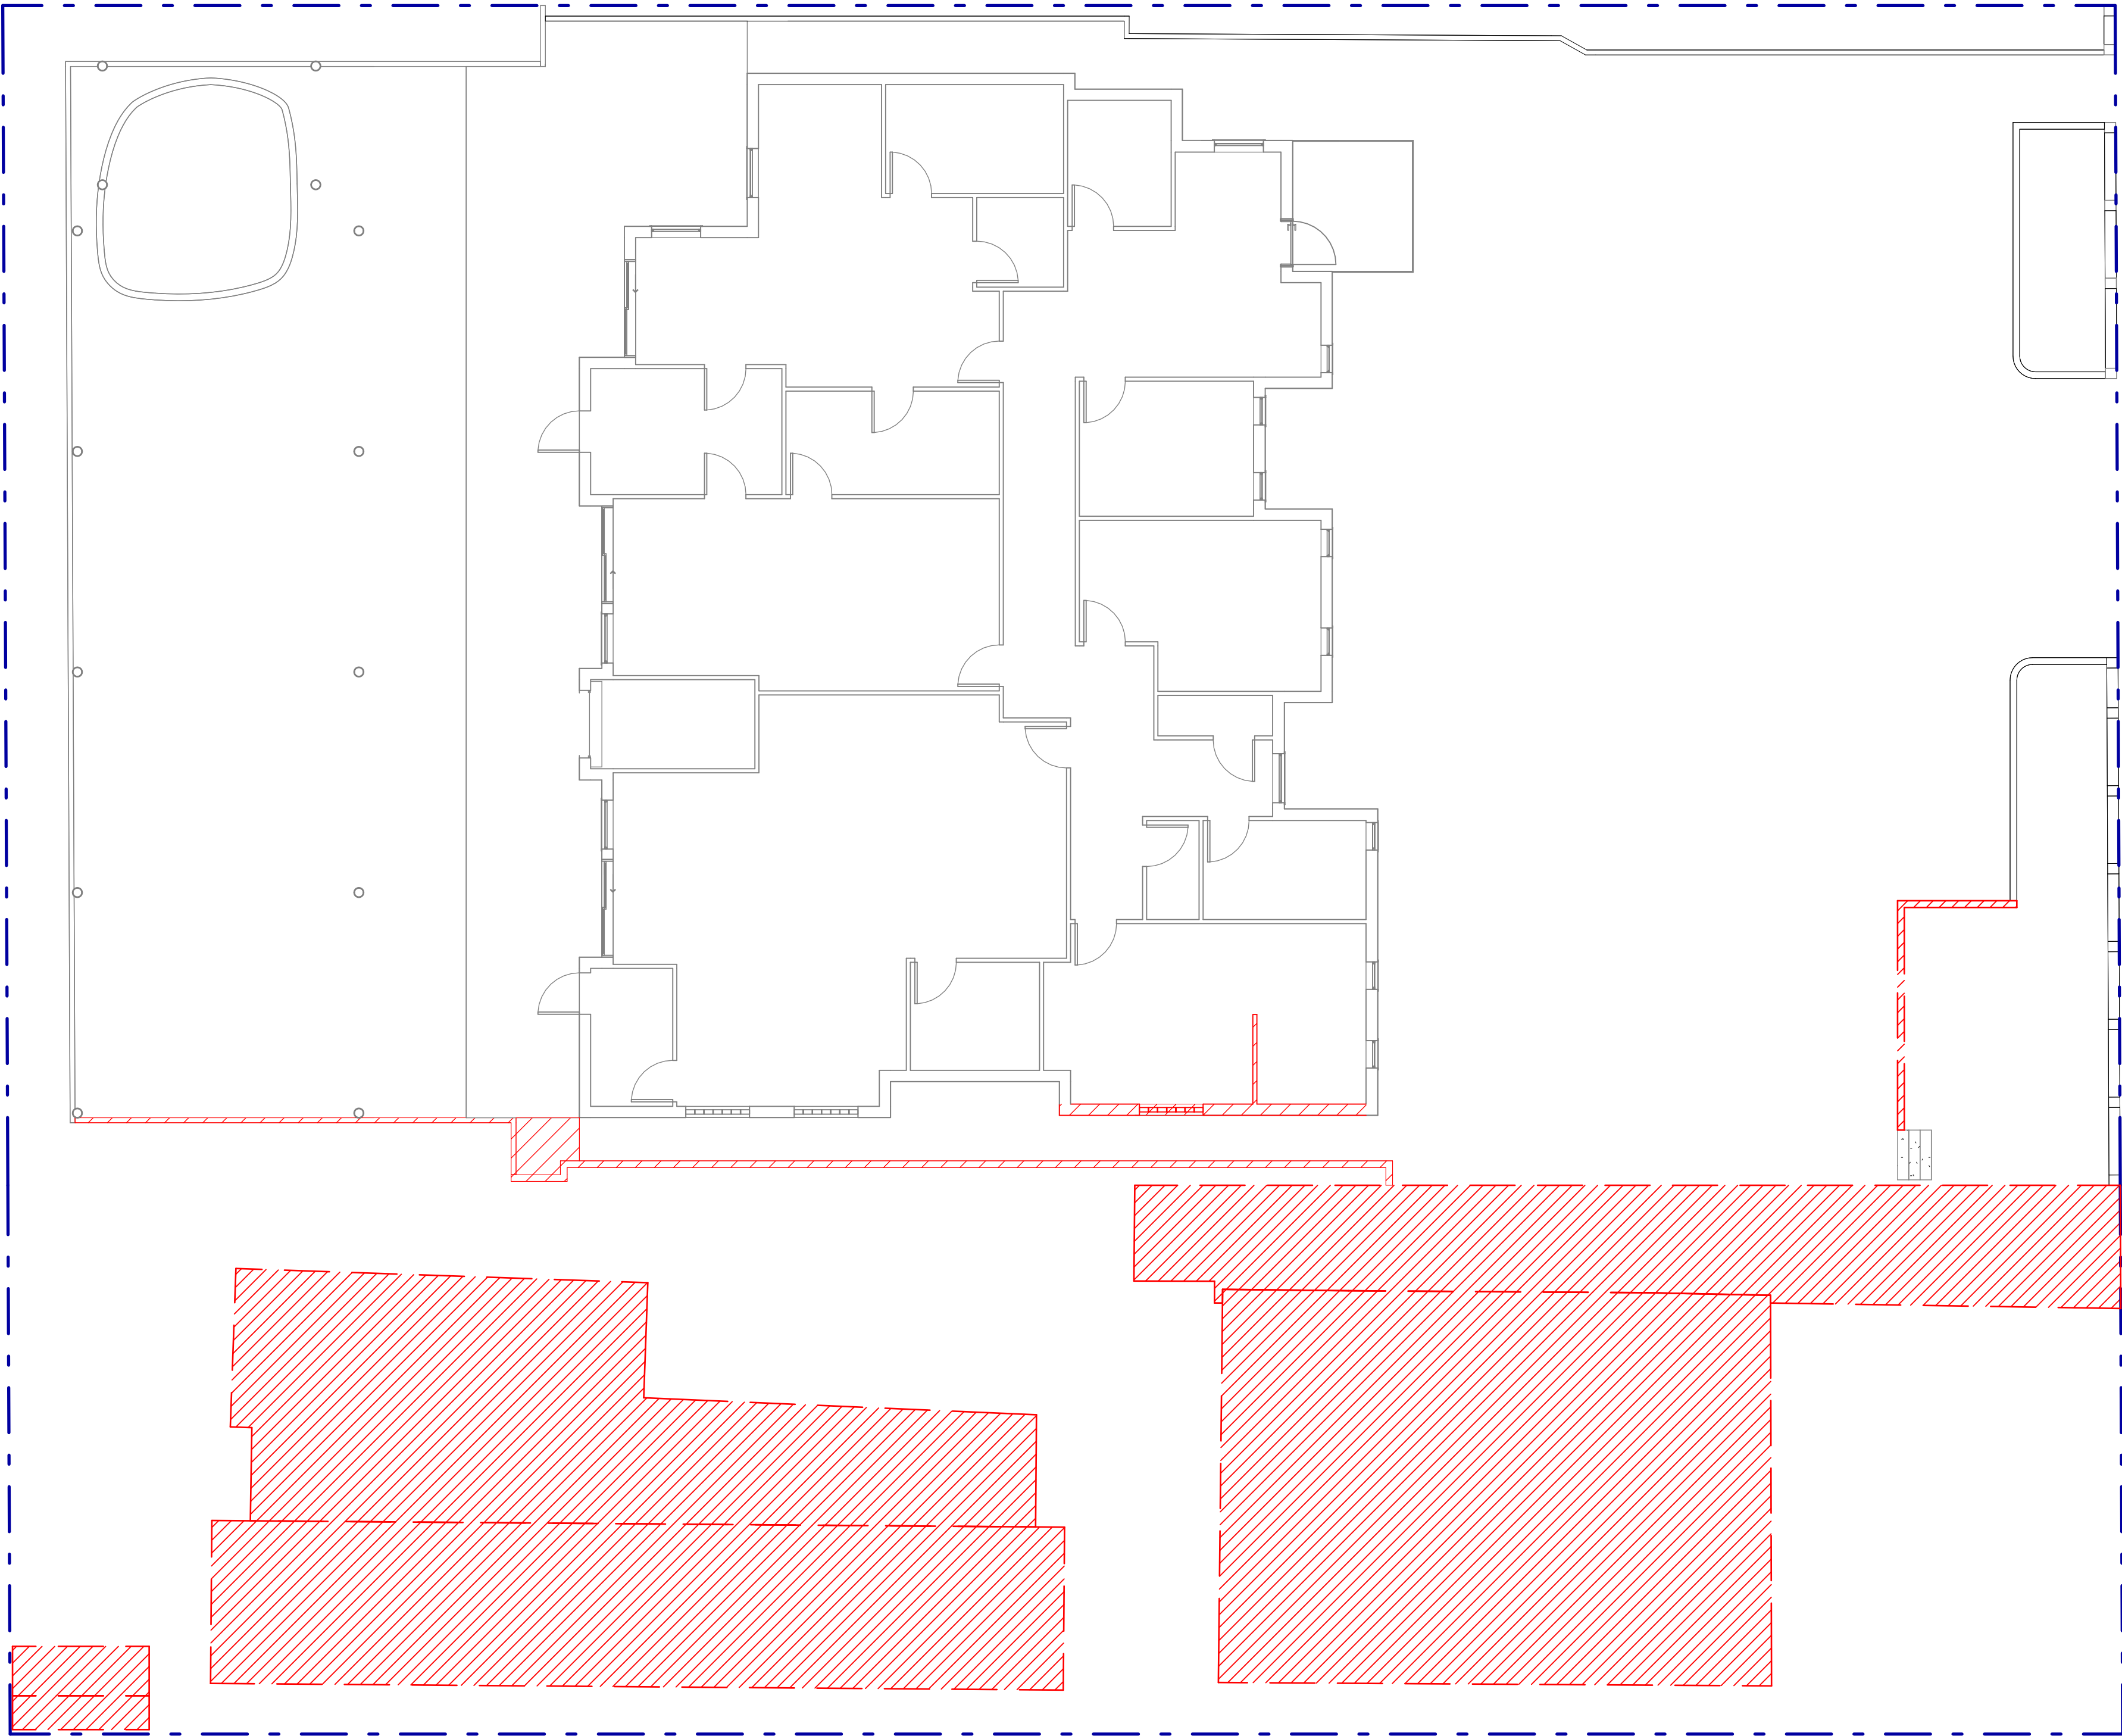


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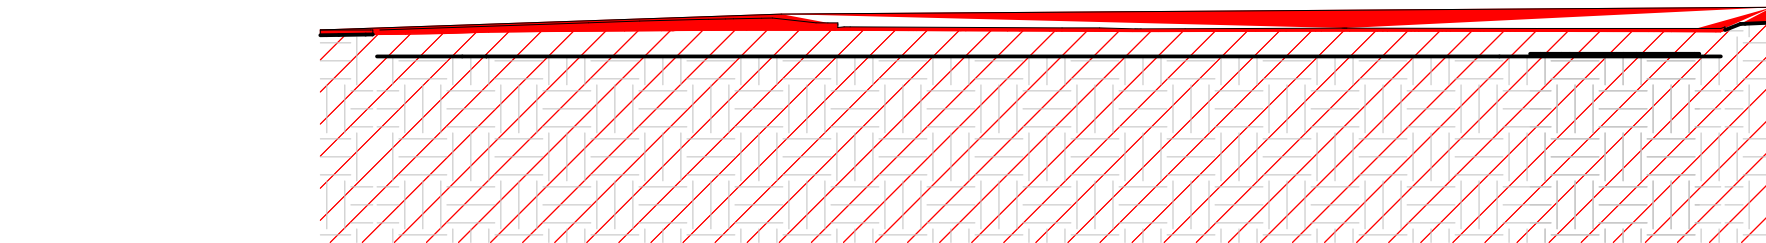
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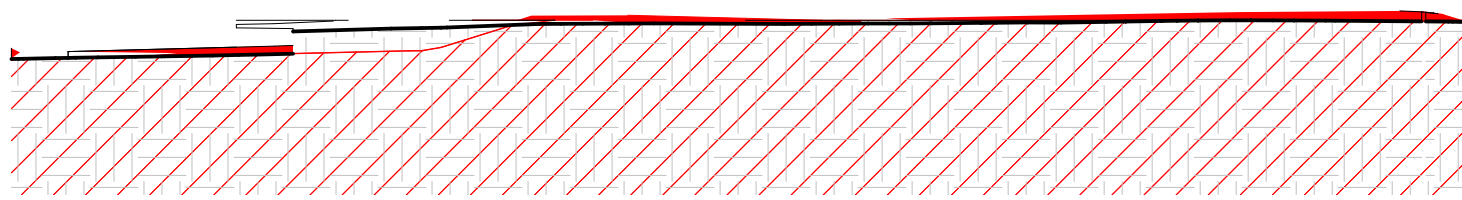
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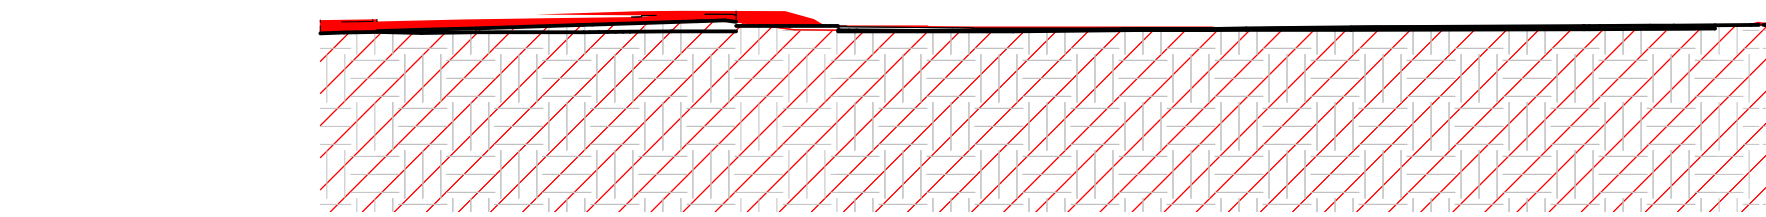
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SCALE: 1 : 200

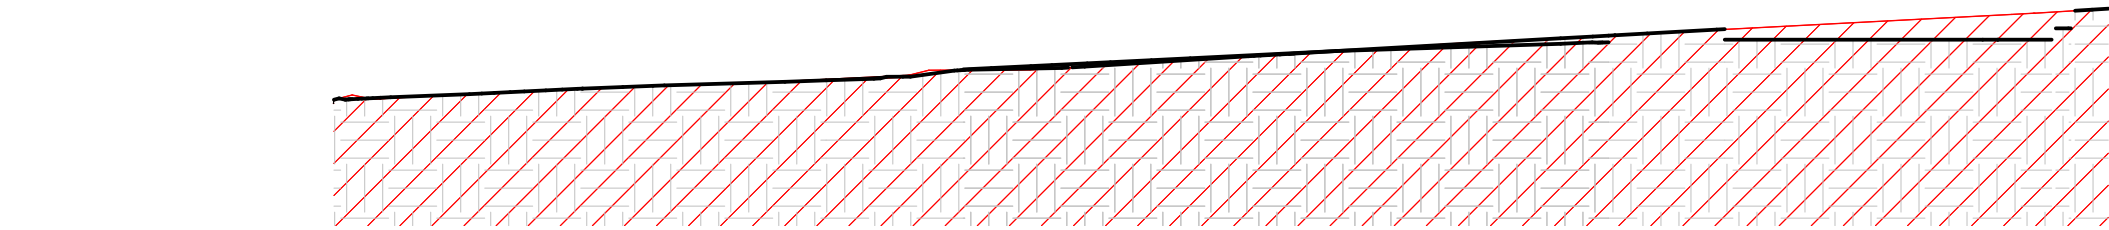

3 Section 3  
SCALE: 1 : 200

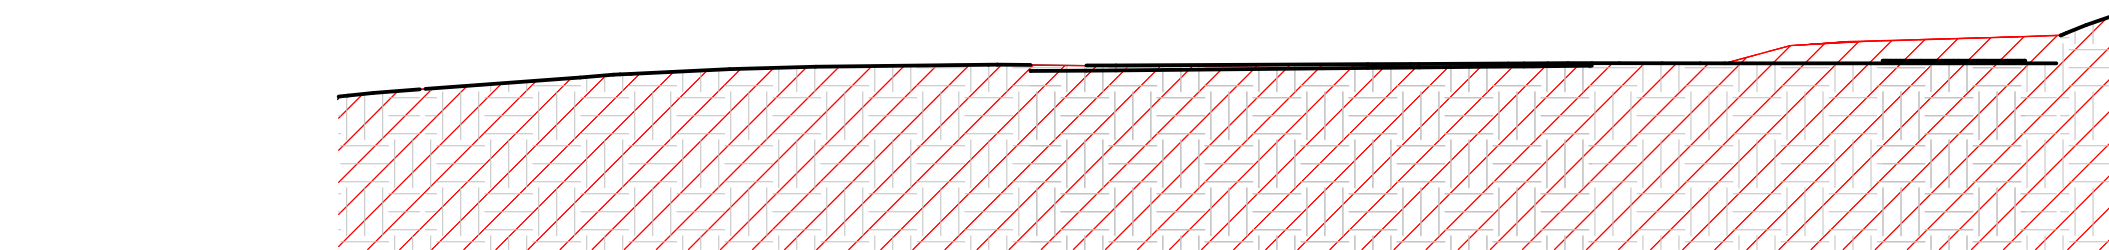

6 Section 6  
SCALE: 1 : 200

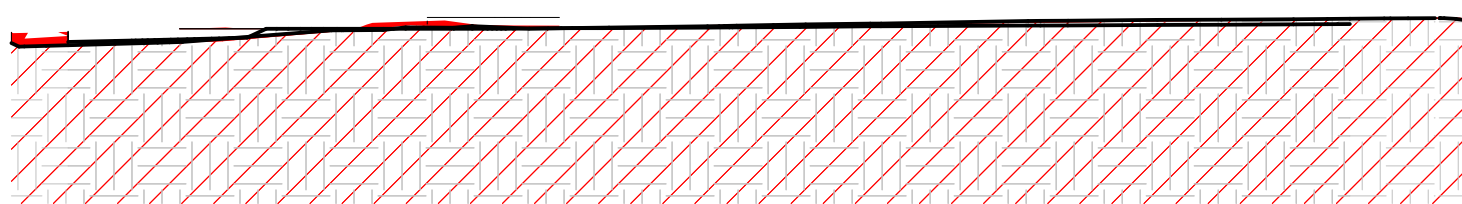

4 Section 4  
SCALE: 1 : 200

Topography Schedule			
Name	Cut	Fill	Net cut/fill
	9.70 m³	0.00 m³	-9.70 m³
	31.74 m³	9.07 m³	-22.67 m³
	0.01 m³	0.07 m³	0.06 m³
	0.67 m³	0.36 m³	-0.31 m³
	2.66 m³	0.00 m³	-2.66 m³
	173.41 m³	3.64 m³	-169.77 m³
	1.97 m³	7.18 m³	5.21 m³
	0.11 m³	0.04 m³	-0.07 m³
	5.41 m³	30.17 m³	24.76 m³
	0.00 m³	0.00 m³	0.00 m³
	0.43 m³	0.02 m³	-0.41 m³
	1.72 m³	0.16 m³	-1.56 m³

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							42 - 44 NORFOLK ROAD, GREENACRE, 2190, NSW	Scale 1 : 200	Page Total TBC	
A	03/10/2024	DA DOCUMENTATION	MA					Drawn By MA	Checked By AA	
REV	DATE	DESCRIPTION	BY				Site Leveling	Date 03/10/2024	Revision A	



SITE INFORMATION

TOTAL SITE AREA: (OVERALL)

ADDRESS  
SUBURB  
COUNCIL  
LOT/DP  
ZONE

CONTROLS

- MAXIMUM FLOOR RATIO
- EXISTING BUILDING
  - PROPOSED GROUND FLOOR
  - PROPOSED FIRST FLOOR
- BUILDING HEIGHT
- SETBACKS (MIN/M)
- PRIMARY FRONT (BUILDING)
  - SIDE (BUILDING)
  - LANDSCAPE (FRONT)
  - LANDSCAPE (REAR)
- PRIVATE OPEN SPACE

REQUIREMENTS

1,802.2 x 0.4 = 720.88m<sup>2</sup>

9m

5.5m  
1.5m  
2m  
1.5m  
80m<sup>2</sup>

SITE INFORMATION


1,802.2m<sup>2</sup>

42 - 44 NORFOLK RD, NSW 2190  
GREENACRE  
CANTERBURY-BANKSTOWN COUNCIL  
LOT B / DP 384997  
R2

PROPOSED WORK


583.31m<sup>2</sup>  
307.14m<sup>2</sup>  
202.05m<sup>2</sup>  
74.12m<sup>2</sup>  
8.7m

13m  
1.5m  
2m  
1.5m  
80m<sup>2</sup>

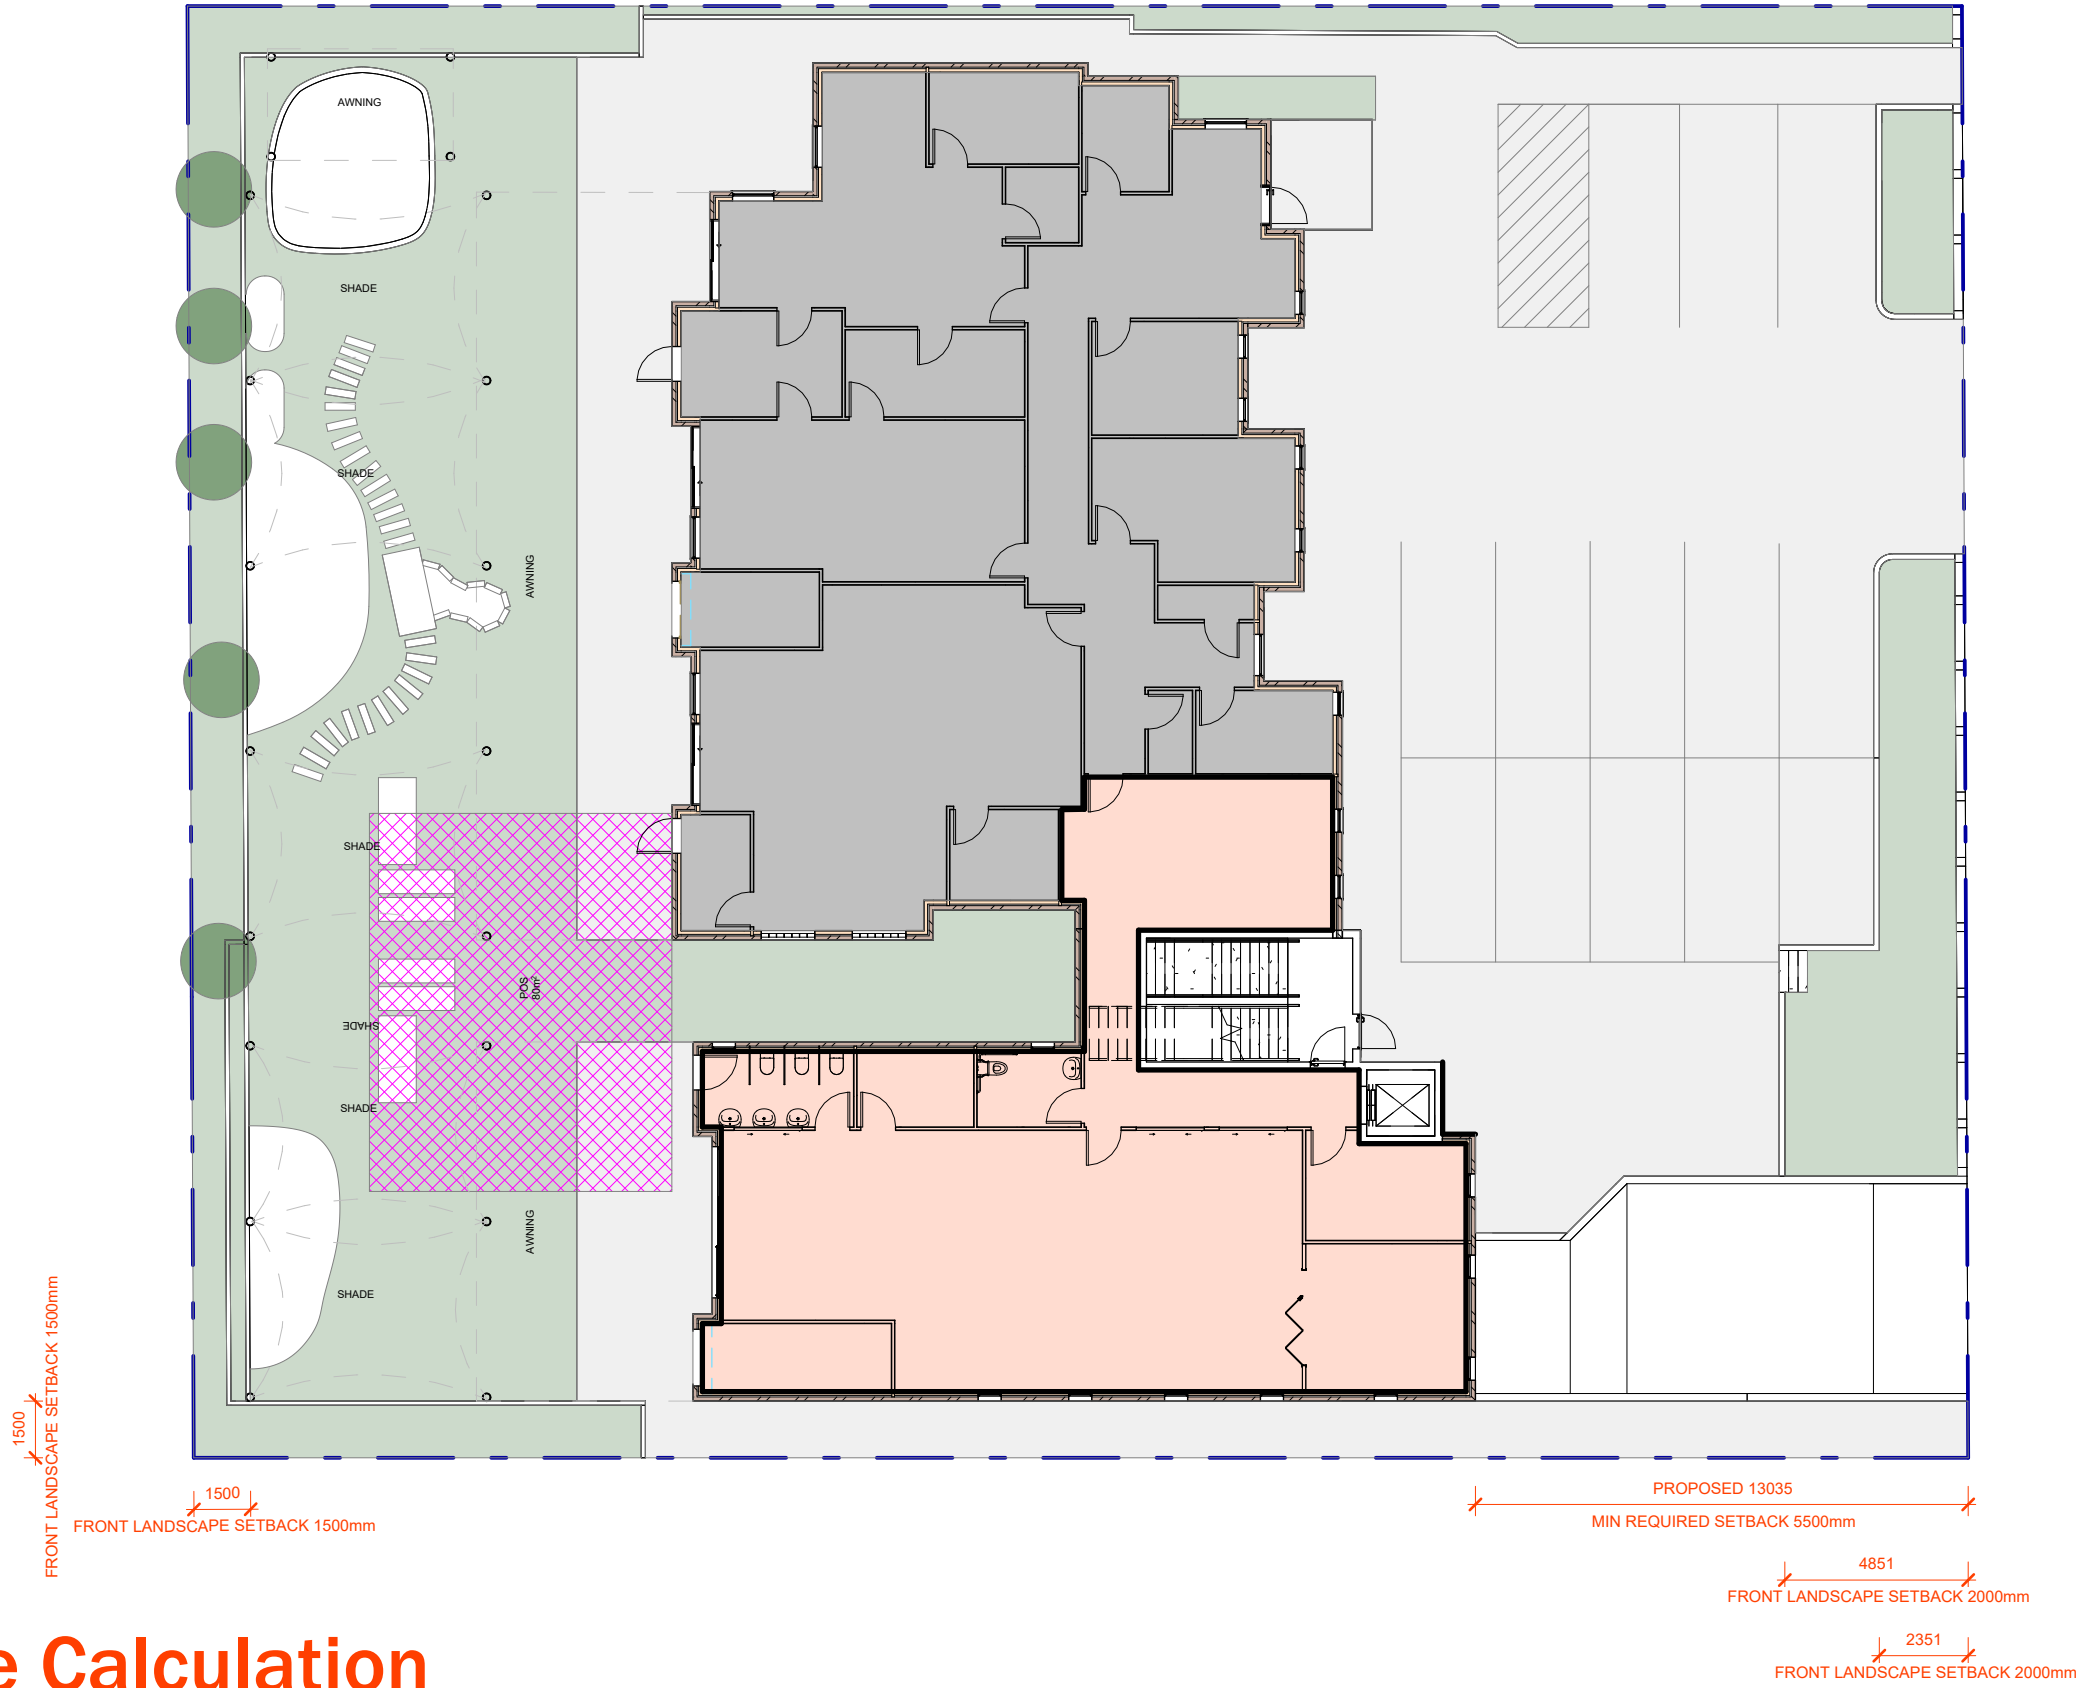

1 GF - Site Calculation

SCALE: 1 : 200

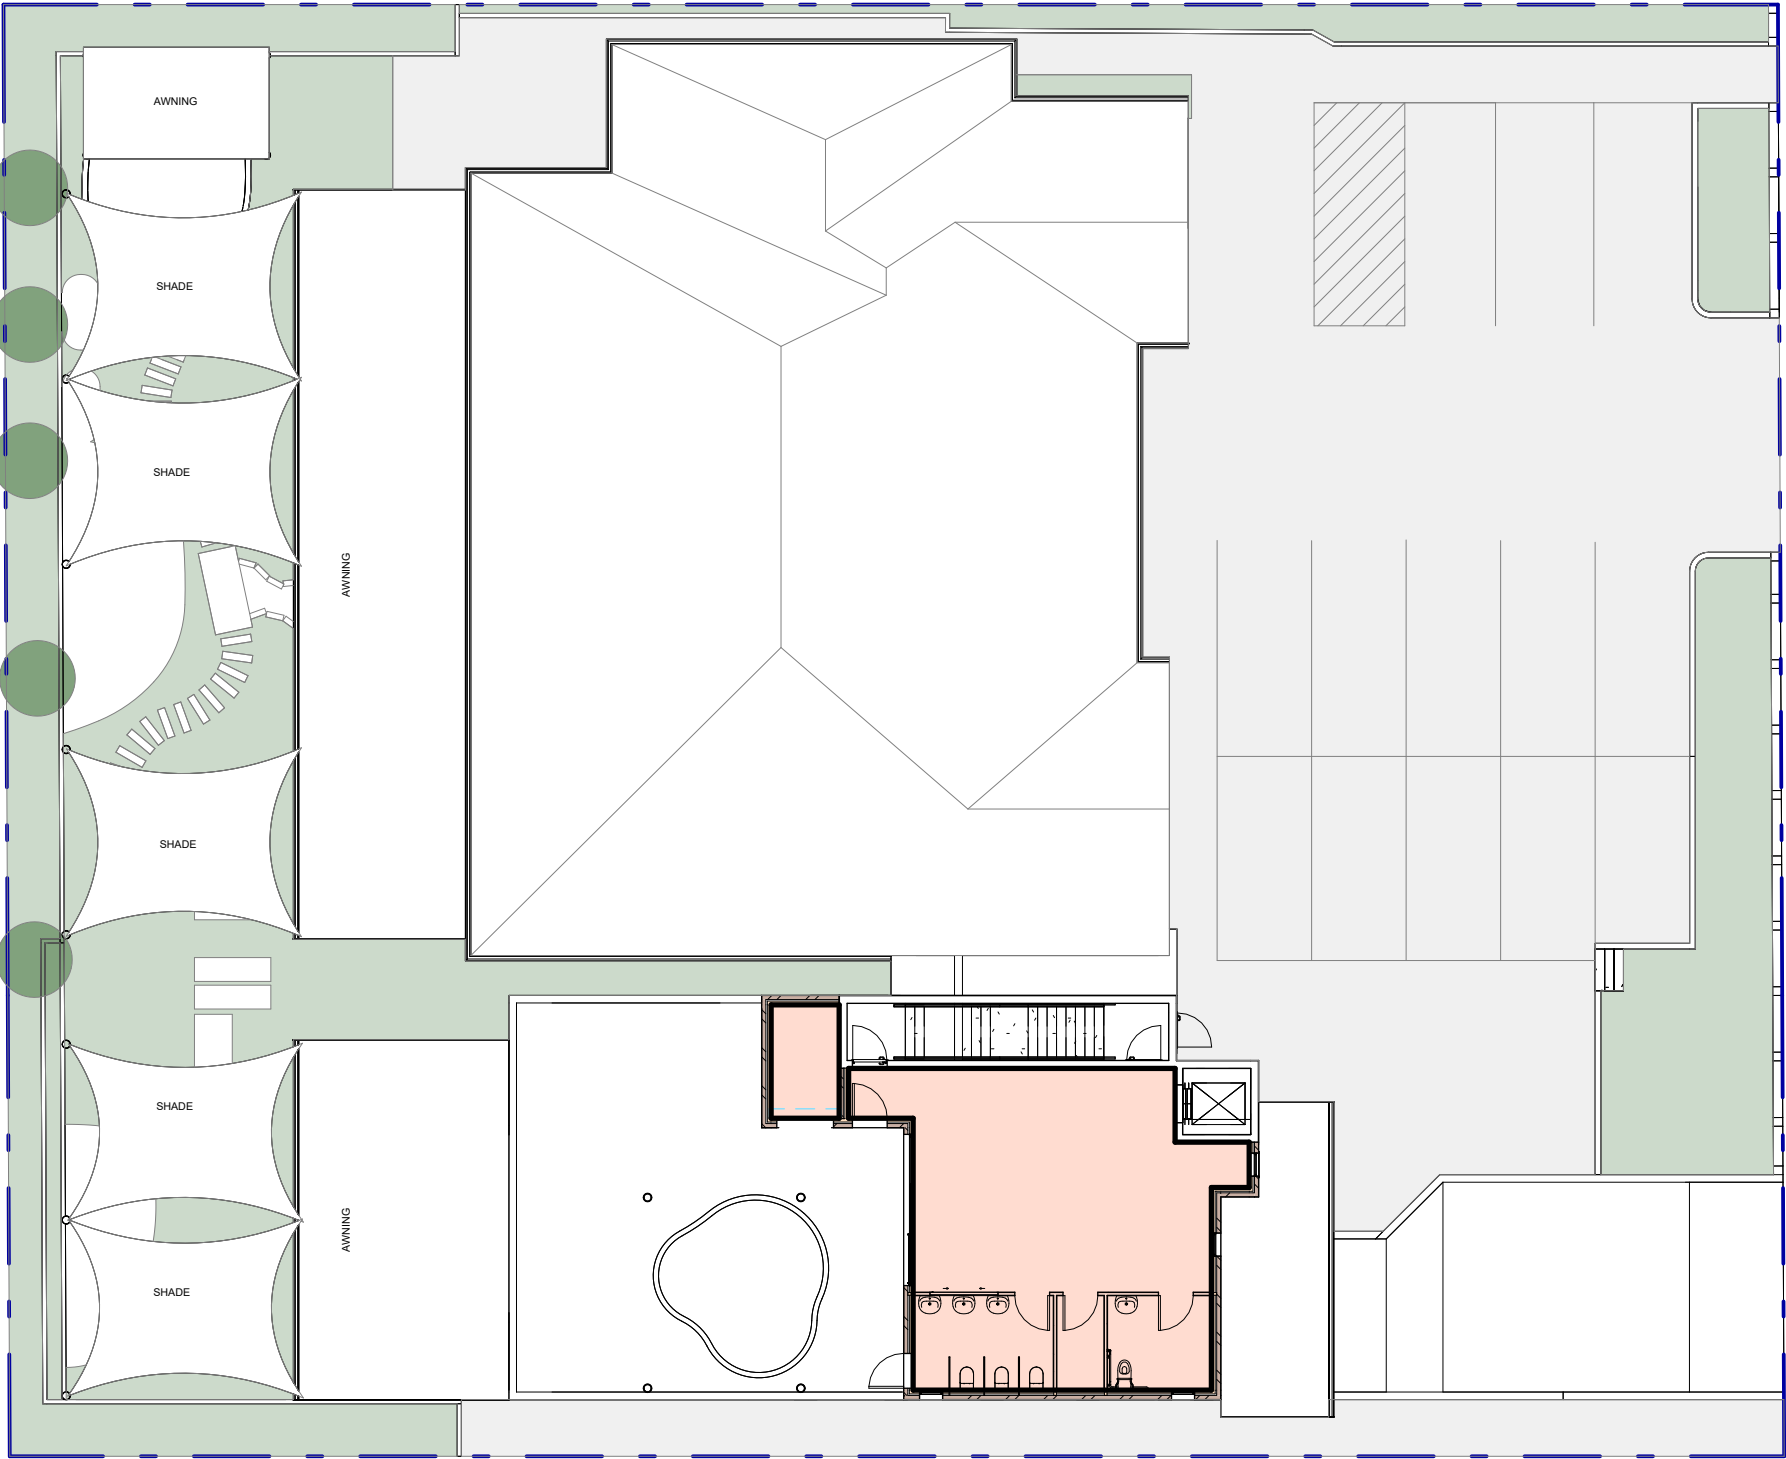

2 FF - Site Calculation

SCALE: 1 : 200

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CONSTRUCTION OF A DOUBLE STORY CHILDCARE, FRONT  
FENCE AND BASEMENT CARPARK

42 - 44 NORFOLK ROAD, GREENACRE, 2190, NSW

Site Requirements

Job Number D2024/06	Drawing Number A02.04	Sheet scale A1
Scale 1 : 200	Page Total TBC	
Drawn By MA	Checked By AA	
Date 03/10/2024	Revision A	



CHILD CARE PLANNING GUIDELINE

EXISTING STUDENT NUMBERS

0-2 FLOOR SPACE REQUIRED	10 x 3.25 = 32.5 m <sup>2</sup>
0-2 FLOOR SPACE EXISTING	35.5 m <sup>2</sup>
0-2 STAFF REQUIRED	10 / 4 = 3
0-2 STAFF EXISTING	3
2-3 FLOOR SPACE REQUIRED	10 x 3.25 = 32.5 m <sup>2</sup>
2-3 FLOOR SPACE EXISTING	35.5 m <sup>2</sup>
2-3 STAFF REQUIRED	10 / 5 = 2
2-3 STAFF EXISTING	2
3-6 FLOOR SPACE REQUIRED	20 x 3.25 = 65 m <sup>2</sup>
3-6 FLOOR SPACE EXISTING	68.9 m <sup>2</sup>
3-6 STAFF REQUIRED	20 / 10 = 2
3-6 STAFF EXISTING	2
3-6 FLOOR SPACE REQUIRED	SEE PAGE A02.06
3-6 FLOOR SPACE PROPOSED	SEE PAGE A02.06
3-6 STAFF REQUIRED	SEE PAGE A02.06
3-6 STAFF PROPOSED	SEE PAGE A02.06
3-6 FLOOR SPACE REQUIRED	SEE PAGE A02.07
3-6 FLOOR SPACE PROPOSED	SEE PAGE A02.07
3-6 STAFF REQUIRED	SEE PAGE A02.07
3-6 STAFF PROPOSED	SEE PAGE A02.07

PROPOSED OUTDOOR SPACE

0-2 PROPOSED	SEE PAGE A02.08
2-3 PROPOSED	SEE PAGE A02.08
3-6 PROPOSED	SEE PAGE A02.08
3-6 PROPOSED	SEE PAGE A02.08

OVERALL REQUIRED	SEE PAGE A02.08
OVERALL PROPOSED	SEE PAGE A02.08

OVERALL SHADED REQUIRED	SEE PAGE A02.08
OVERALL SHADED PROPOSED	SEE PAGE A02.08

PROPOSED PARKING

REQUIRED SPACES	SEE PAGE A02.09
PROPOSED SPACES	SEE PAGE A02.09
EXISTING SPACES	SEE PAGE A02.09

OVERALL REQUIRED	SEE PAGE A02.09
OVERALL SPACES	SEE PAGE A02.09

CHILD CARE GUIDELINE

REQUIRED VISTOR OFF-STREET PARKING	SEE PAGE A02.09
PROPOSED VISTOR OFF-STREET PARKING	SEE PAGE A02.09
REQUIRED STAFF OFF-STREET PARKING	SEE PAGE A02.09
PROPOSED STAFF OFF-STREET PARKING	SEE PAGE A02.09

EXISTING STUDENT NUMBERS

PROPOSED OUTDOOR SPACE

PROPOSED PARKING

CHILD CARE GUIDELINE



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CONSTRUCTION OF A DOUBLE STORY CHILDCARE, FRONT  
FENCE AND BASEMENT CARPARK

42 - 44 NORFOLK ROAD, GREENACRE, 2190, NSW

Existing GF Room Calculation

Job Number D2024/06	Drawing Number A02.05	Sheet scale A1
Scale 1 : 100	Page Total TBC	
Drawn By MA	Checked By AA	
Date 03/10/2024	Revision A	



PROPOSED STUDENT NUMBERS

0-2 FLOOR SPACE REQUIRED	SEE PAGE A02.05
0-2 FLOOR SPACE PROPOSED	SEE PAGE A02.05
0-2 STAFF REQUIRED	SEE PAGE A02.05
0-2 STAFF PROPOSED	SEE PAGE A02.05
2-3 FLOOR SPACE REQUIRED	SEE PAGE A02.05
2-3 FLOOR SPACE PROPOSED	SEE PAGE A02.05
2-3 STAFF REQUIRED	SEE PAGE A02.05
2-3 STAFF PROPOSED	SEE PAGE A02.05
3-6 FLOOR SPACE REQUIRED	SEE PAGE A02.05
3-6 FLOOR SPACE PROPOSED	SEE PAGE A02.05
3-6 STAFF REQUIRED	SEE PAGE A02.05
3-6 STAFF PROPOSED	SEE PAGE A02.05
3-6 FLOOR SPACE REQUIRED	30 x 3.25 = 97.5 m <sup>2</sup>
3-6 FLOOR SPACE PROPOSED	97.5 m <sup>2</sup>
3-6 STAFF REQUIRED	30 / 10 = 3
3-6 STAFF PROPOSED	3
3-6 FLOOR SPACE REQUIRED	SEE PAGE A02.07
3-6 FLOOR SPACE PROPOSED	SEE PAGE A02.07
3-6 STAFF REQUIRED	SEE PAGE A02.07
3-6 STAFF PROPOSED	SEE PAGE A02.07

PROPOSED OUTDOOR SPACE

0-2 PROPOSED	SEE PAGE A02.08
2-3 PROPOSED	SEE PAGE A02.08
3-6 PROPOSED	SEE PAGE A02.08
3-6 PROPOSED	SEE PAGE A02.08
OVERALL REQUIRED	SEE PAGE A02.08
OVERALL PROPOSED	SEE PAGE A02.08
OVERALL SHADED REQUIRED	SEE PAGE A02.08
OVERALL SHADED PROPOSED	SEE PAGE A02.08

PROPOSED PARKING

REQUIRED SPACES	SEE PAGE A02.09
PROPOSED SPACES	SEE PAGE A02.09
EXISTING SPACES	SEE PAGE A02.09
OVERALL REQUIRED	SEE PAGE A02.09
OVERALL SPACES	SEE PAGE A02.09

CHILD CARE GUIDELINE

REQUIRED VISTOR OFF-STREET PARKING	SEE PAGE A02.09
PROPOSED VISTOR OFF-STREET PARKING	SEE PAGE A02.09
REQUIRED STAFF OFF-STREET PARKING	SEE PAGE A02.09
PROPOSED STAFF OFF-STREET PARKING	SEE PAGE A02.09

PROPOSED STUDENT NUMBERS

0-2 FLOOR SPACE REQUIRED	SEE PAGE A02.05
0-2 FLOOR SPACE PROPOSED	SEE PAGE A02.05
0-2 STAFF REQUIRED	SEE PAGE A02.05
0-2 STAFF PROPOSED	SEE PAGE A02.05
2-3 FLOOR SPACE REQUIRED	SEE PAGE A02.05
2-3 FLOOR SPACE PROPOSED	SEE PAGE A02.05
2-3 STAFF REQUIRED	SEE PAGE A02.05
2-3 STAFF PROPOSED	SEE PAGE A02.05
3-6 FLOOR SPACE REQUIRED	SEE PAGE A02.05
3-6 FLOOR SPACE PROPOSED	SEE PAGE A02.05
3-6 STAFF REQUIRED	SEE PAGE A02.05
3-6 STAFF PROPOSED	SEE PAGE A02.05
3-6 FLOOR SPACE REQUIRED	30 x 3.25 = 97.5 m <sup>2</sup>
3-6 FLOOR SPACE PROPOSED	97.5 m <sup>2</sup>
3-6 STAFF REQUIRED	30 / 10 = 3
3-6 STAFF PROPOSED	3
3-6 FLOOR SPACE REQUIRED	SEE PAGE A02.07
3-6 FLOOR SPACE PROPOSED	SEE PAGE A02.07
3-6 STAFF REQUIRED	SEE PAGE A02.07
3-6 STAFF PROPOSED	SEE PAGE A02.07

PROPOSED OUTDOOR SPACE


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2-3 PROPOSED	SEE PAGE A02.08
3-6 PROPOSED	SEE PAGE A02.08
3-6 PROPOSED	SEE PAGE A02.08
OVERALL REQUIRED	SEE PAGE A02.08
OVERALL PROPOSED	SEE PAGE A02.08
OVERALL SHADED REQUIRED	SEE PAGE A02.08
OVERALL SHADED PROPOSED	SEE PAGE A02.08

PROPOSED PARKING

REQUIRED SPACES	SEE PAGE A02.09
PROPOSED SPACES	SEE PAGE A02.09
EXISTING SPACES	SEE PAGE A02.09
OVERALL REQUIRED	SEE PAGE A02.09
OVERALL SPACES	SEE PAGE A02.09

CHILD CARE GUIDELINE

REQUIRED VISTOR OFF-STREET PARKING	SEE PAGE A02.09
PROPOSED VISTOR OFF-STREET PARKING	SEE PAGE A02.09
REQUIRED STAFF OFF-STREET PARKING	SEE PAGE A02.09
PROPOSED STAFF OFF-STREET PARKING	SEE PAGE A02.09

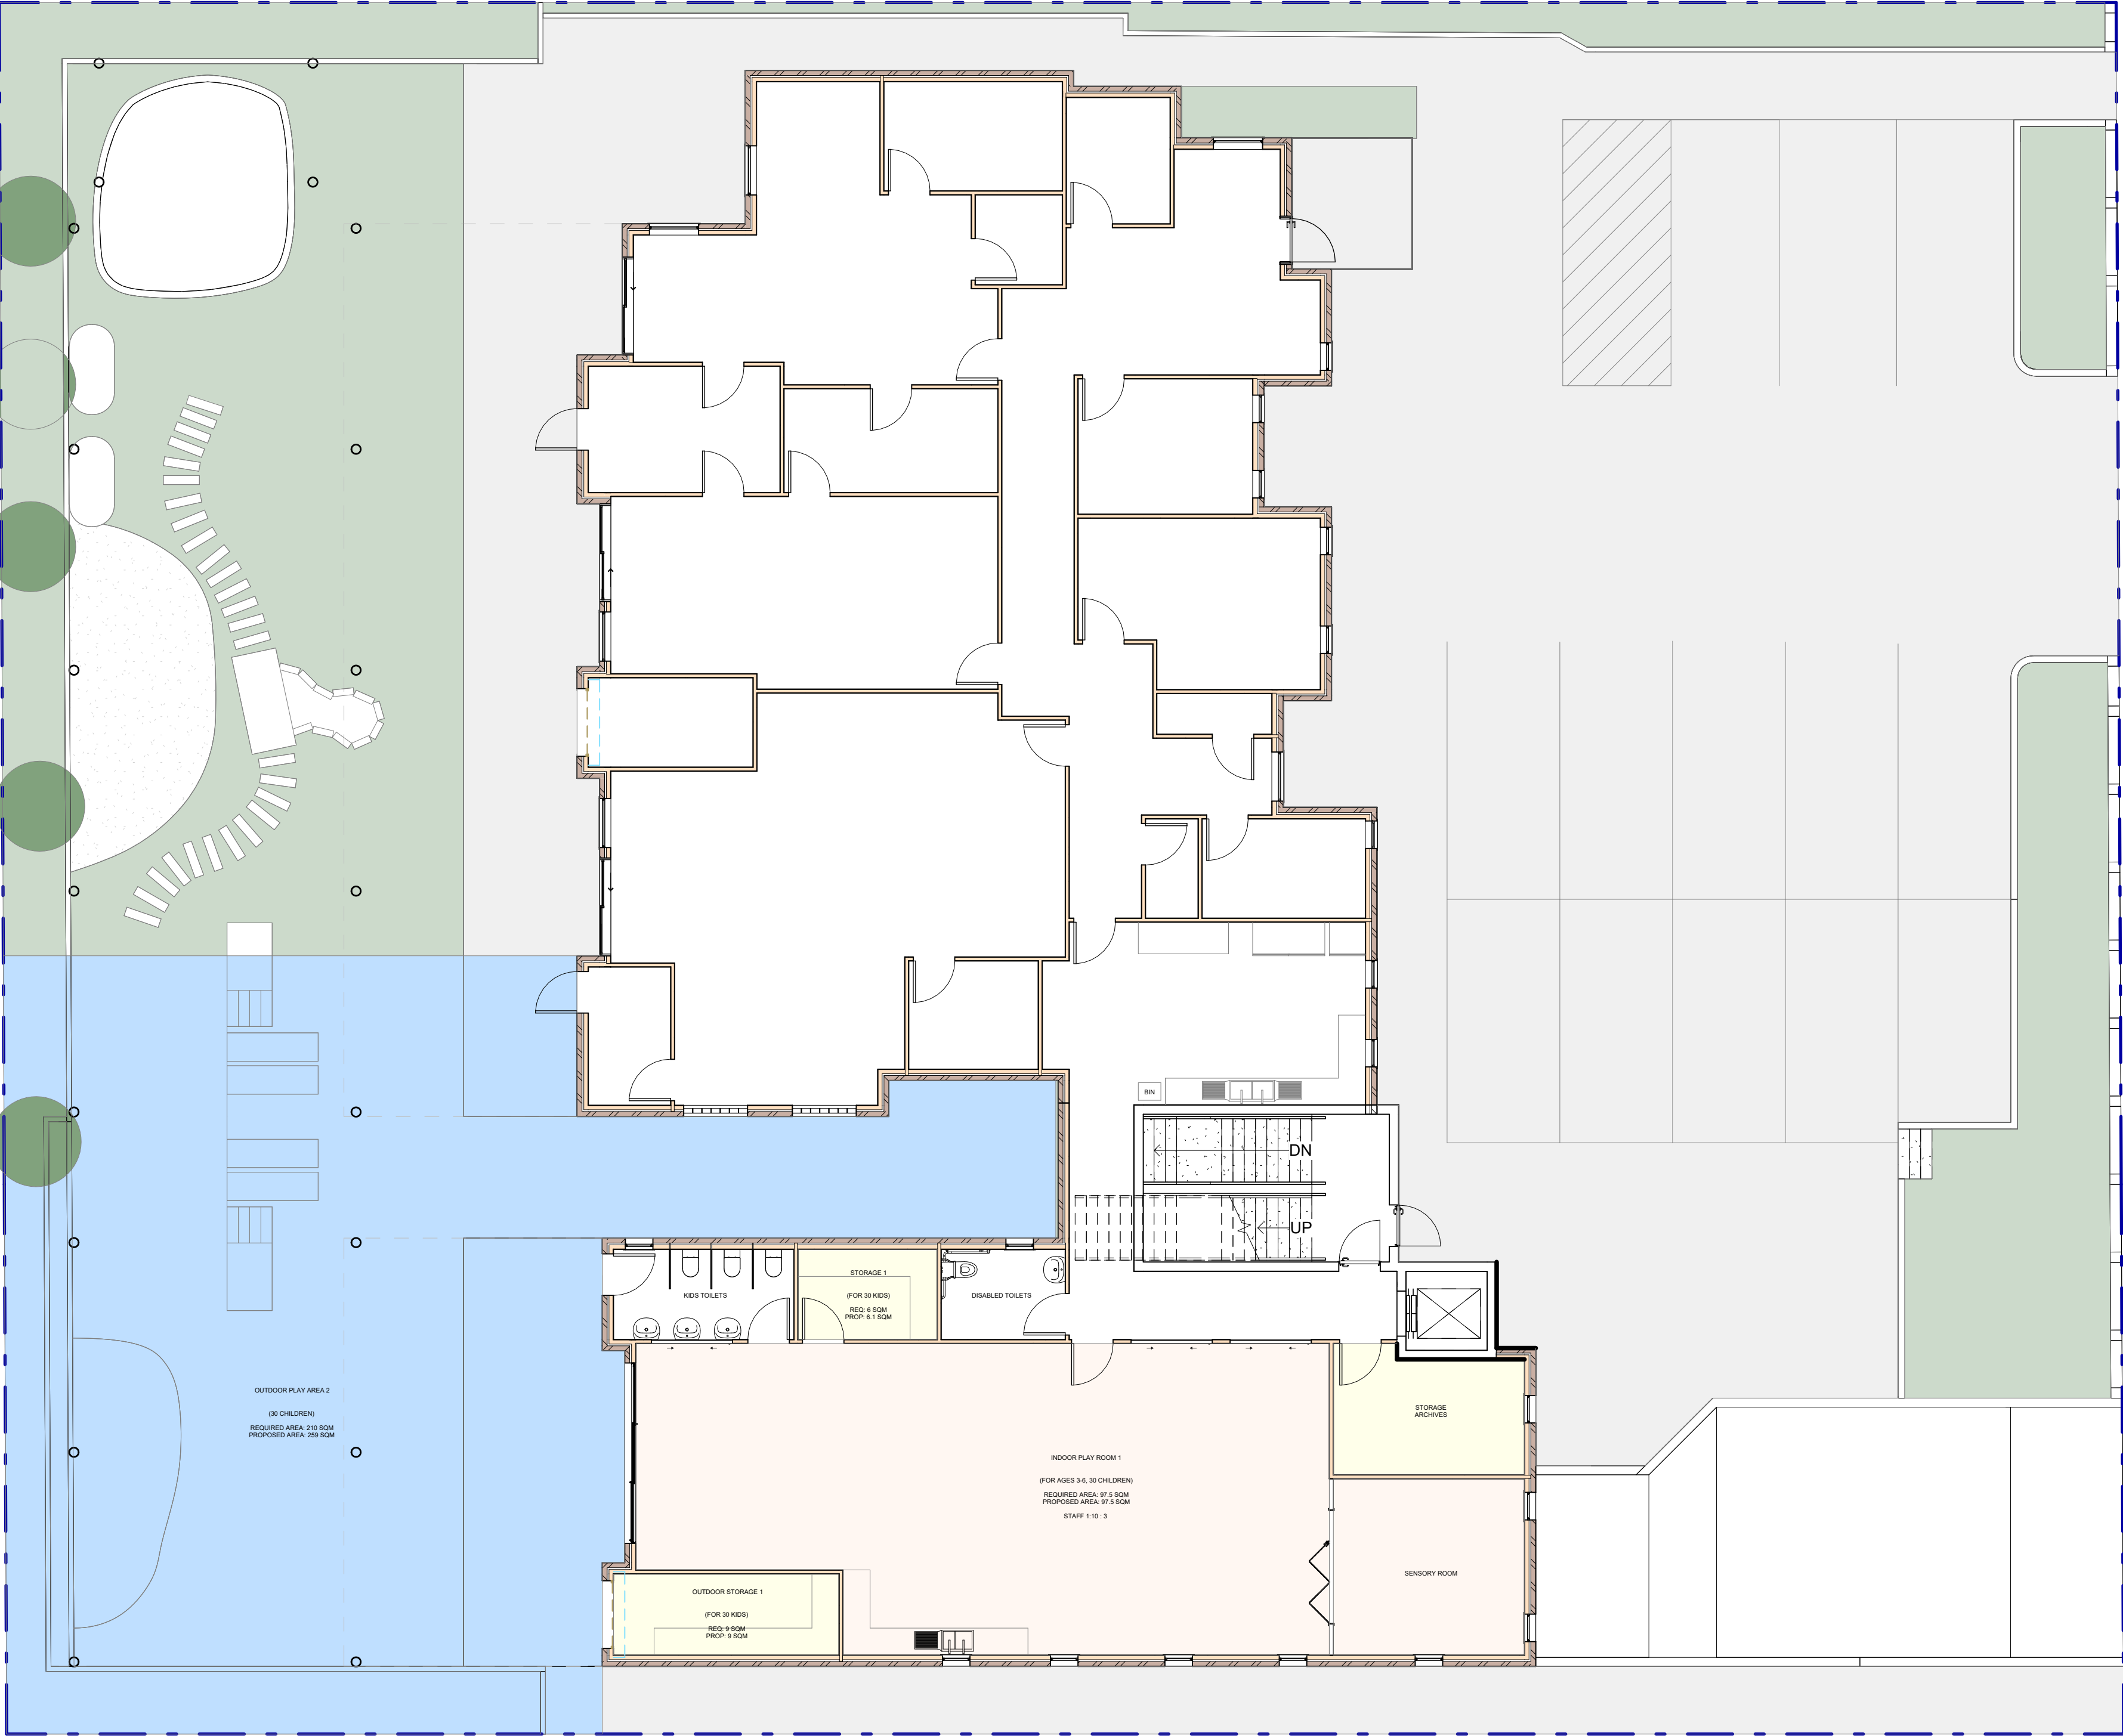

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CONSTRUCTION OF A DOUBLE STORY CHILDCARE, FRONT FENCE AND BASEMENT CARPARK	Job Number D2024/06	Drawing Number A02.06	Sheet scale A1
42 - 44 NORFOLK ROAD, GREENACRE, 2190, NSW	Scale 1 : 100	Page Total TBC	
Proposed GF Room Calculation	Drawn By MA	Checked By AA	
	Date 03/10/2024	Revision A	



PROPOSED STUDENT NUMBERS

0-2 FLOOR SPACE REQUIRED	SEE PAGE A02.05
0-2 FLOOR SPACE PROPOSED	SEE PAGE A02.05
0-2 STAFF REQUIRED	SEE PAGE A02.05
0-2 STAFF PROPOSED	SEE PAGE A02.05
2-3 FLOOR SPACE REQUIRED	SEE PAGE A02.05
2-3 FLOOR SPACE PROPOSED	SEE PAGE A02.05
2-3 STAFF REQUIRED	SEE PAGE A02.05
2-3 STAFF PROPOSED	SEE PAGE A02.05
3-6 FLOOR SPACE REQUIRED	SEE PAGE A02.05
3-6 FLOOR SPACE PROPOSED	SEE PAGE A02.05
3-6 STAFF REQUIRED	SEE PAGE A02.05
3-6 STAFF PROPOSED	SEE PAGE A02.05
3-6 FLOOR SPACE REQUIRED	SEE PAGE A02.06
3-6 FLOOR SPACE PROPOSED	SEE PAGE A02.06
3-6 STAFF REQUIRED	SEE PAGE A02.06
3-6 STAFF PROPOSED	SEE PAGE A02.06
3-6 FLOOR SPACE REQUIRED	10 x 3.25 = 32.5 m <sup>2</sup>
3-6 FLOOR SPACE PROPOSED	52 m <sup>2</sup>
3-6 STAFF REQUIRED	10 / 10 = 1
3-6 STAFF PROPOSED	1

PROPOSED OUTDOOR SPACE

0-2 PROPOSED	SEE PAGE A02.08
2-3 PROPOSED	SEE PAGE A02.08
3-6 PROPOSED	SEE PAGE A02.08
3-6 PROPOSED	SEE PAGE A02.08
OVERALL REQUIRED	SEE PAGE A02.08
OVERALL PROPOSED	SEE PAGE A02.08
OVERALL SHADED REQUIRED	SEE PAGE A02.08
OVERALL SHADED PROPOSED	SEE PAGE A02.08

PROPOSED PARKING

REQUIRED SPACES	SEE PAGE A02.09
PROPOSED SPACES	SEE PAGE A02.09
EXISTING SPACES	SEE PAGE A02.09
OVERALL REQUIRED	SEE PAGE A02.09
OVERALL SPACES	SEE PAGE A02.09

CHILD CARE GUIDELINE


REQUIRED VISTOR OFF-STREET PARKING	SEE PAGE A02.09
PROPOSED VISTOR OFF-STREET PARKING	SEE PAGE A02.09
REQUIRED STAFF OFF-STREET PARKING	SEE PAGE A02.09
PROPOSED STAFF OFF-STREET PARKING	SEE PAGE A02.09

PROPOSED STUDENT NUMBERS

PROPOSED OUTDOOR SPACE

PROPOSED PARKING

CHILD CARE GUIDELINE

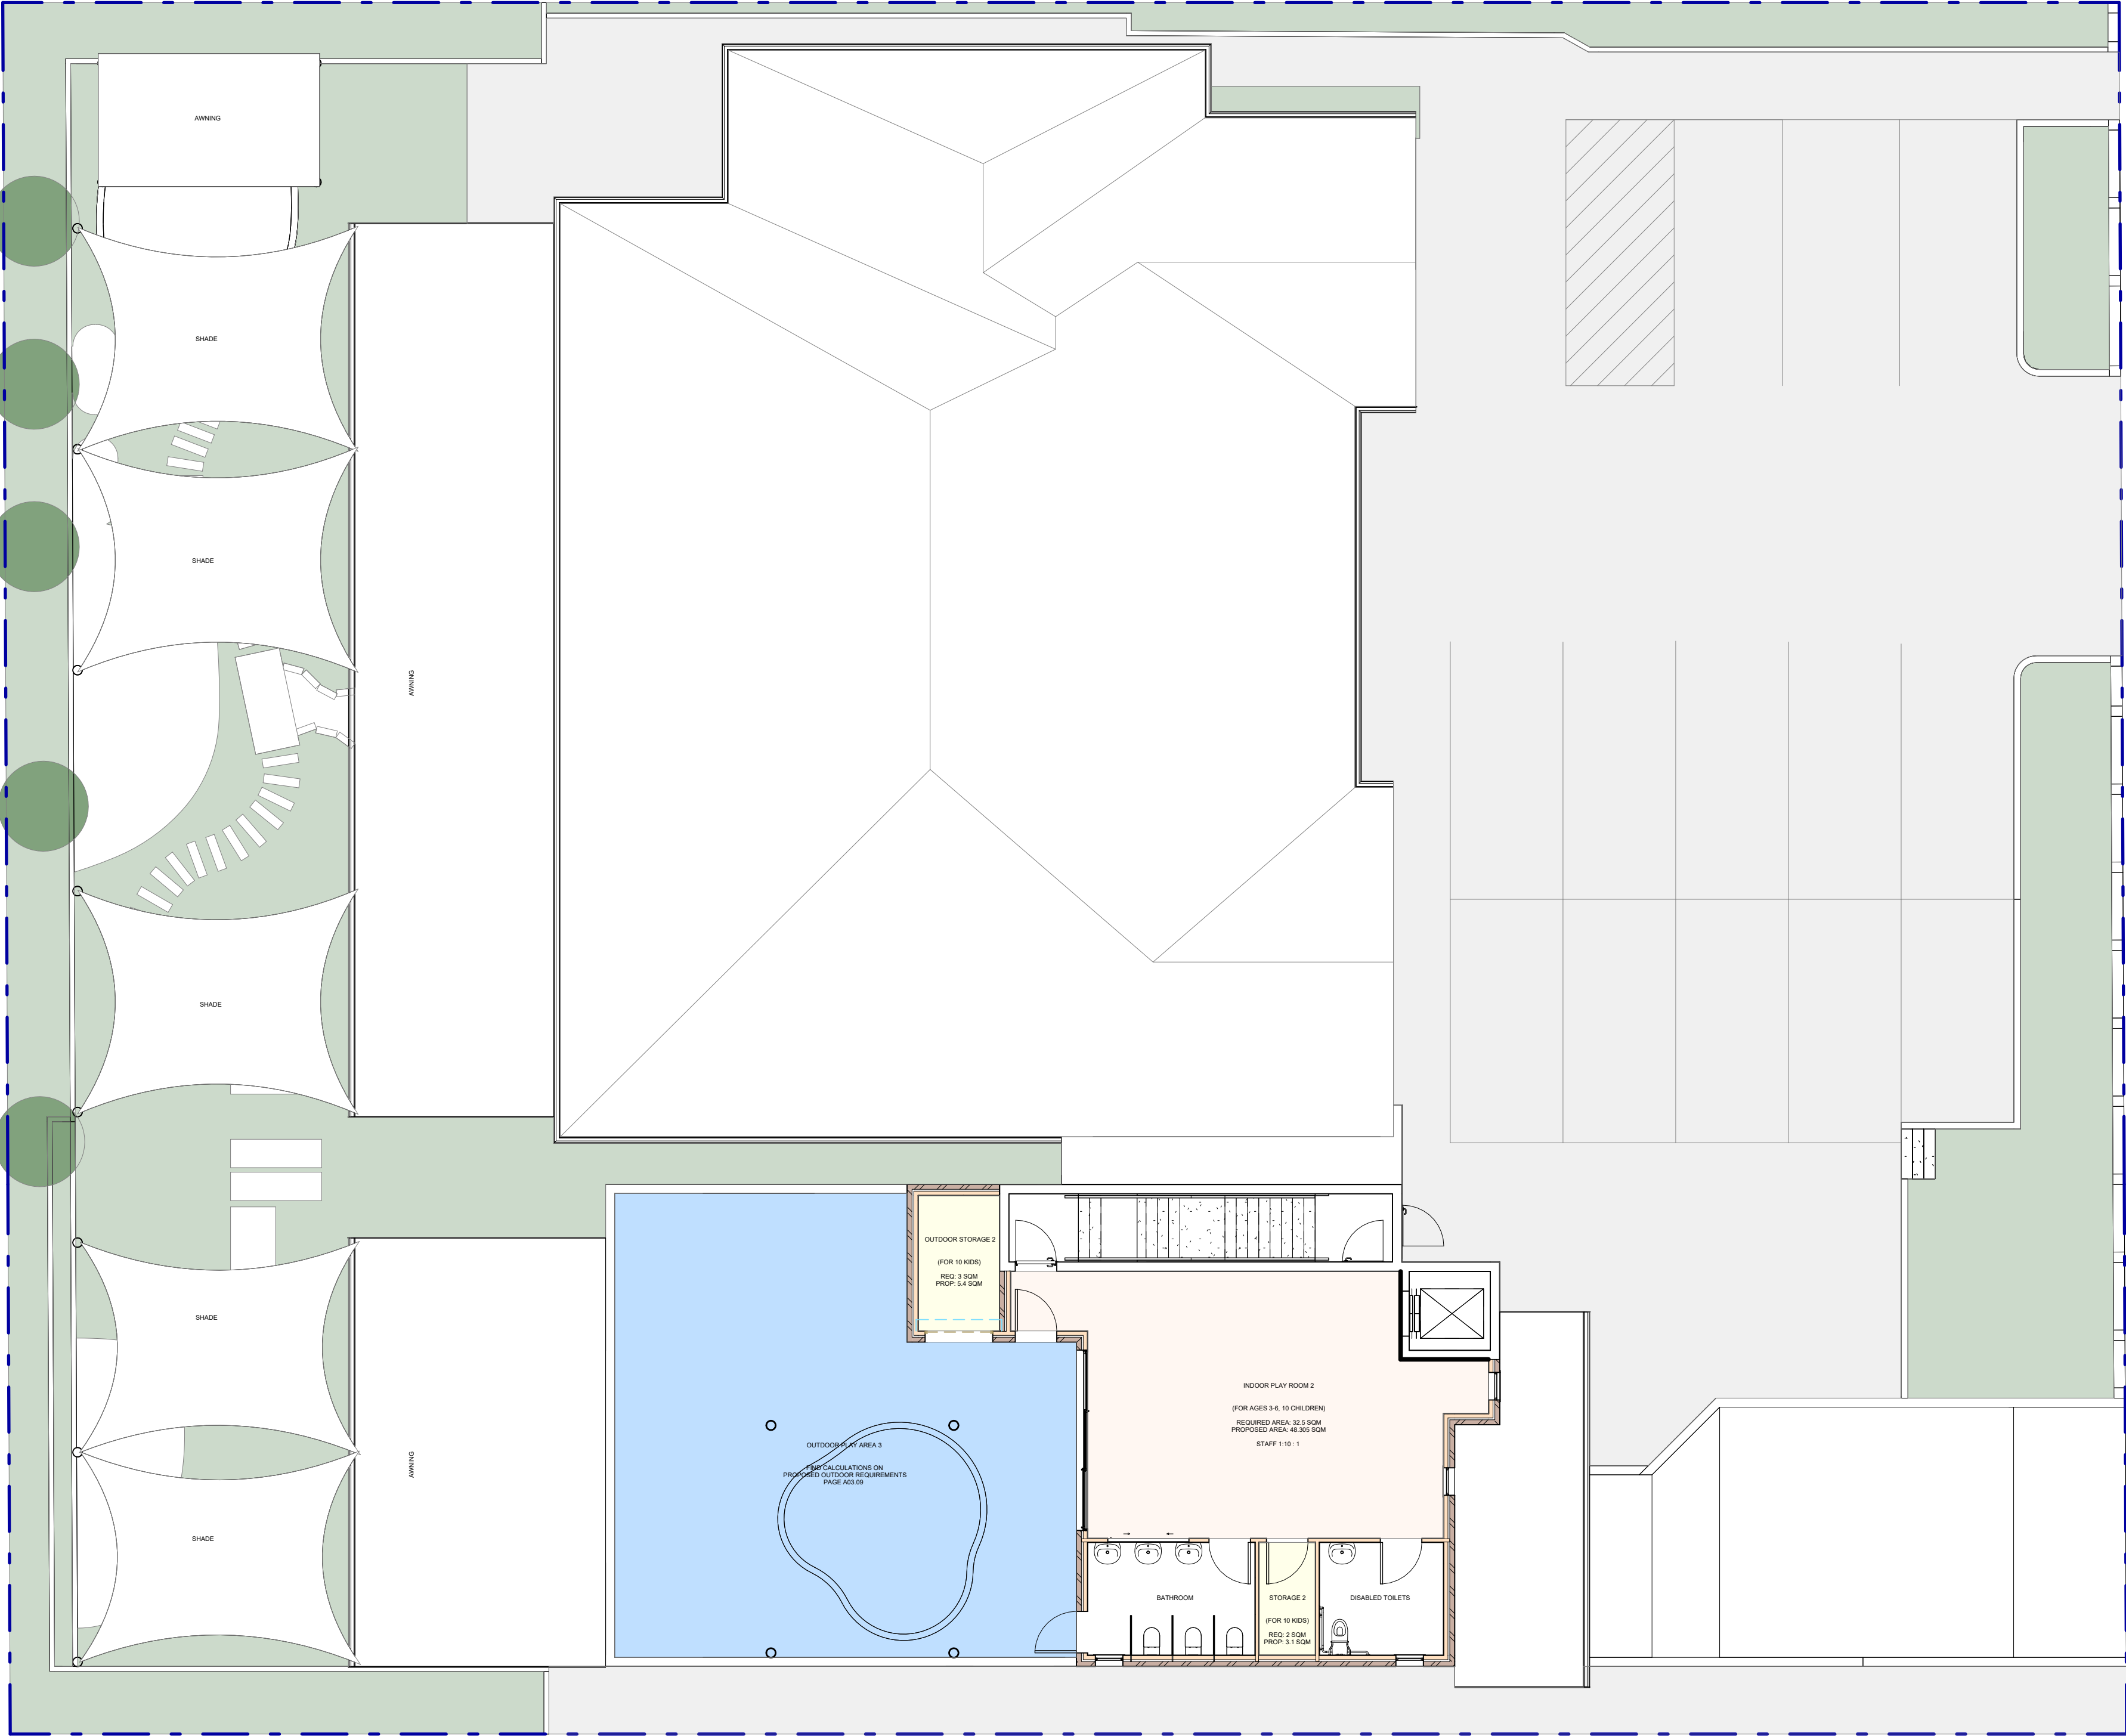

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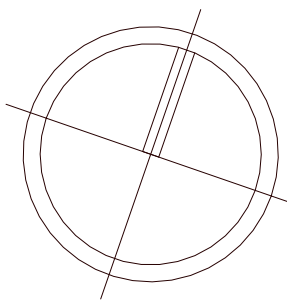
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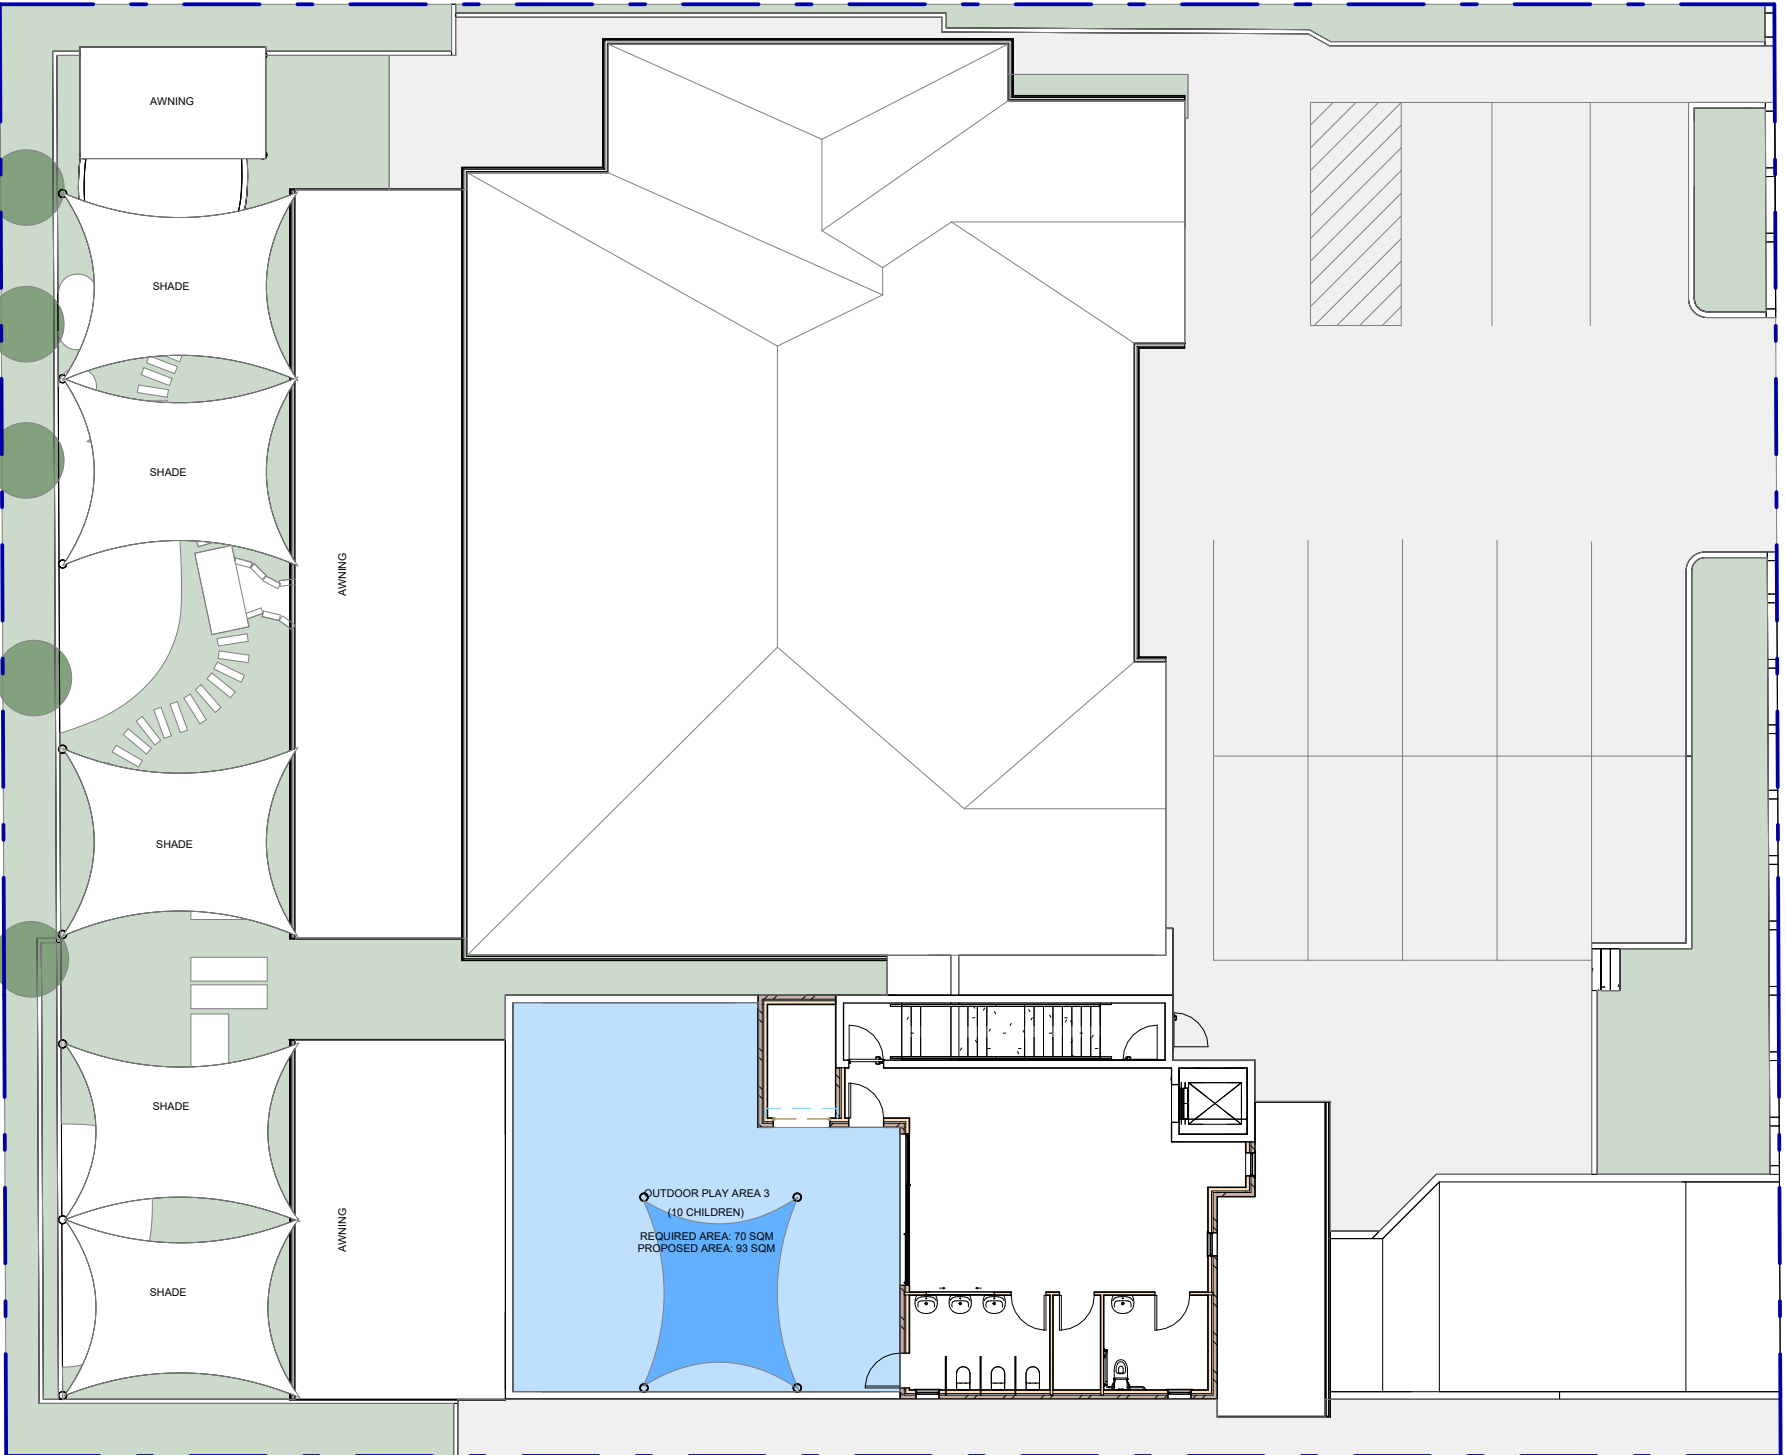
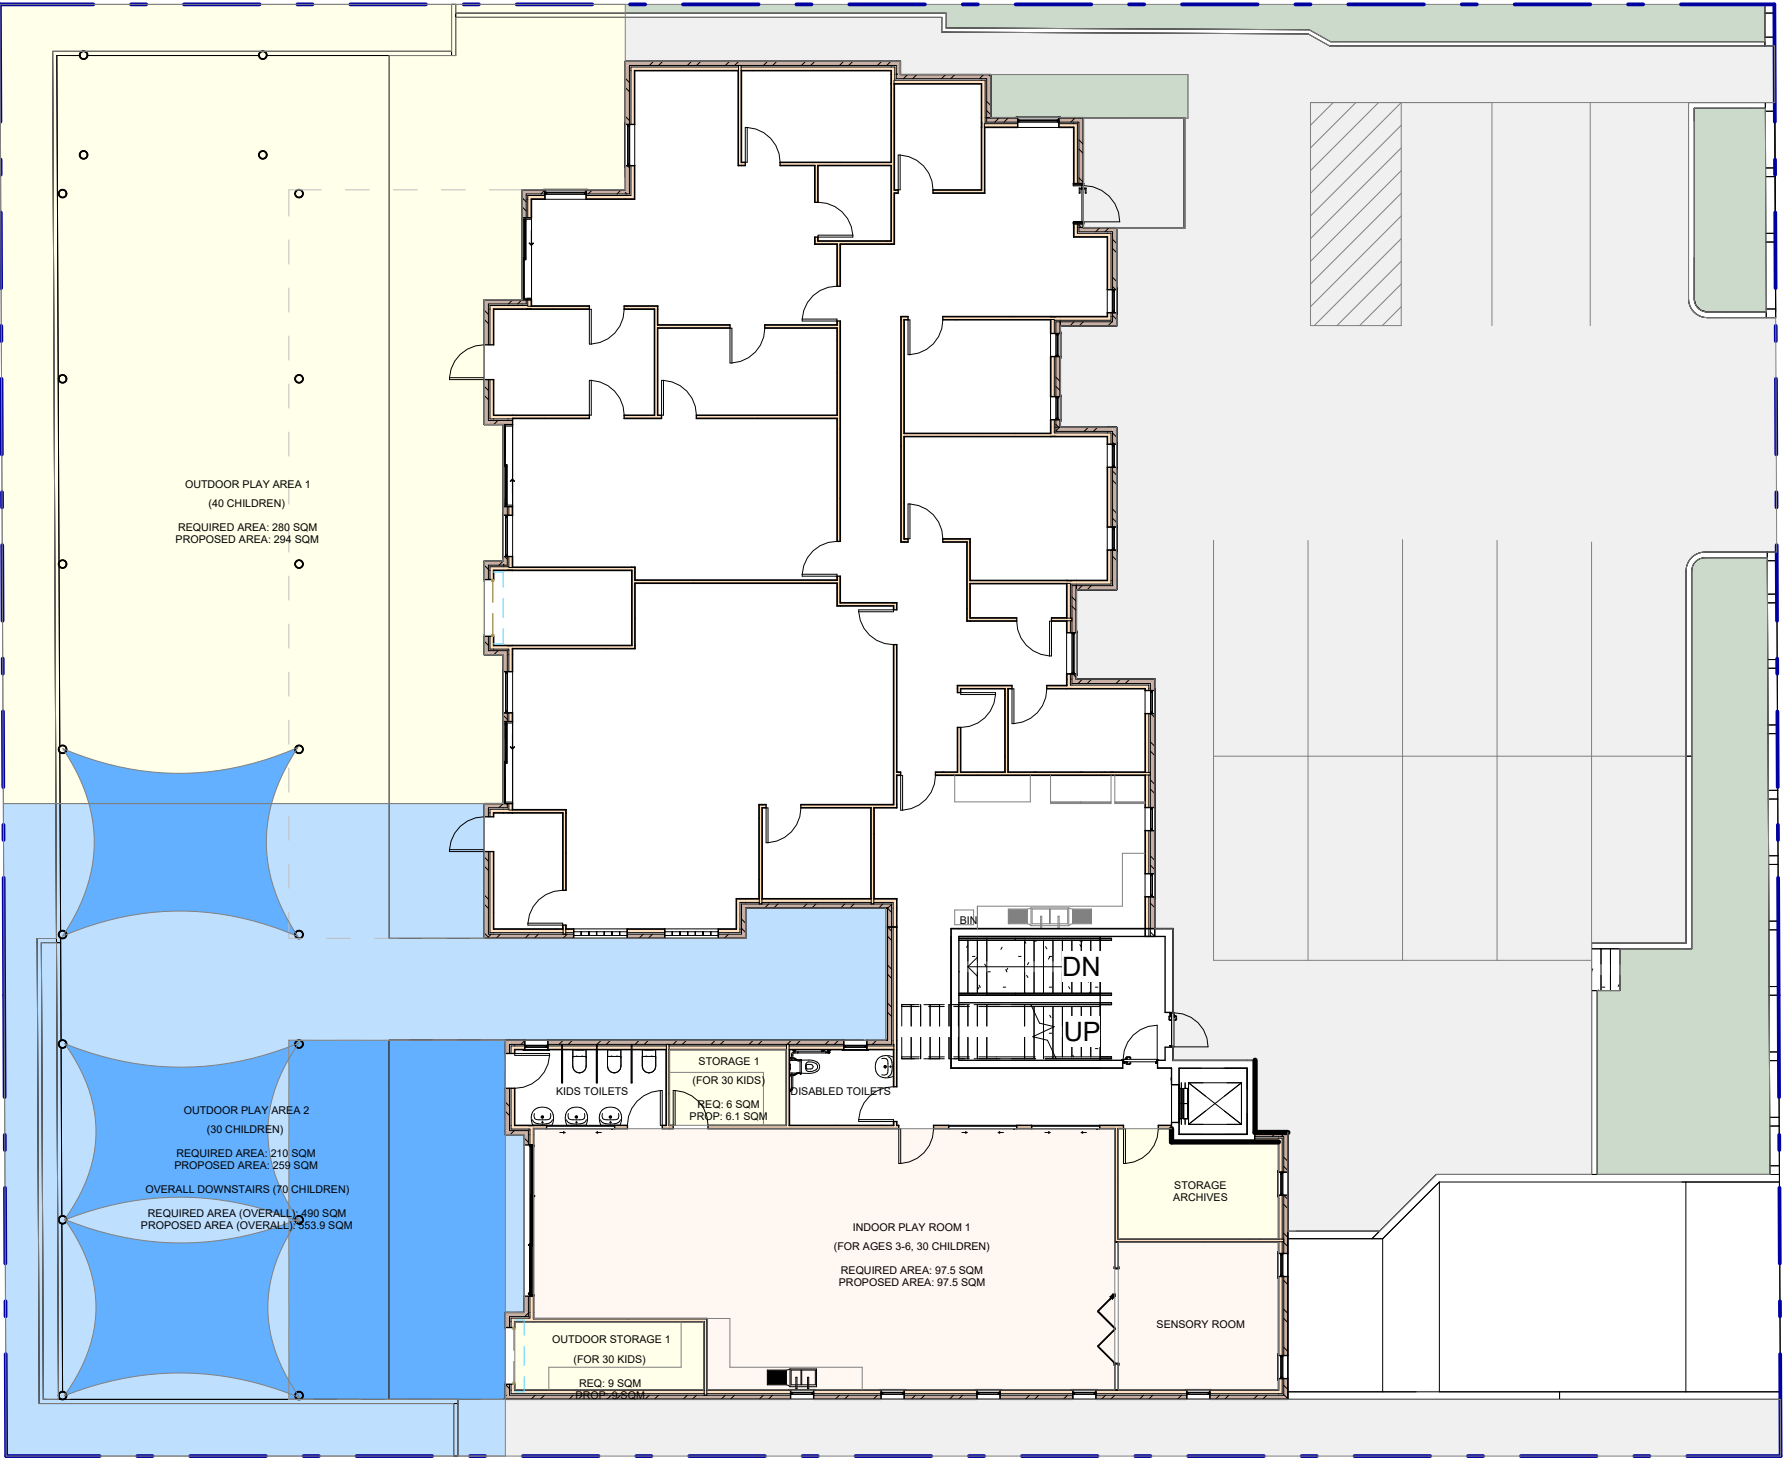
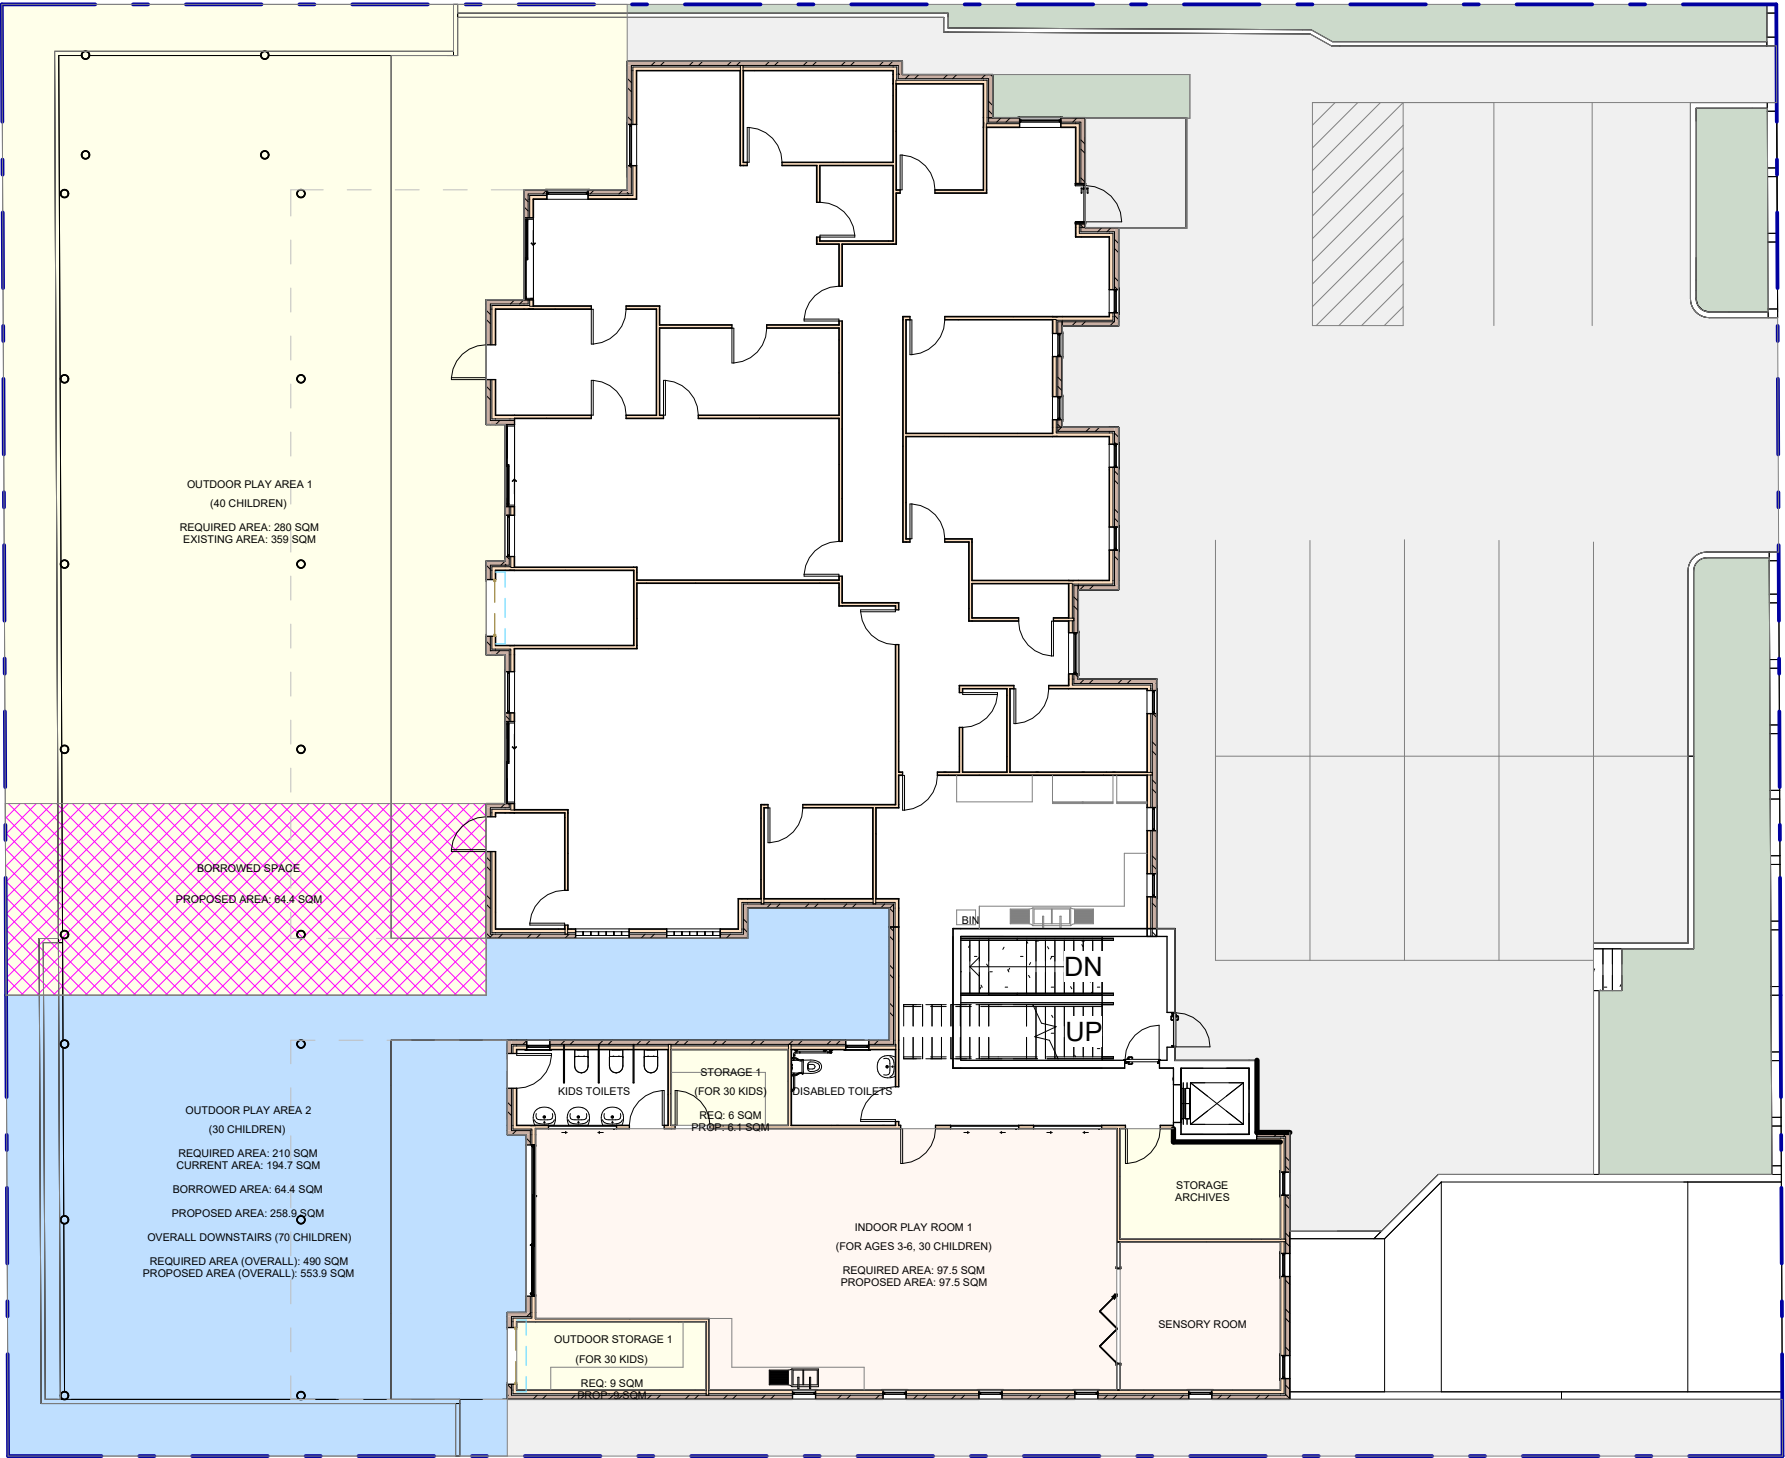
CONSTRUCTION OF A DOUBLE STORY CHILDCARE, FRONT FENCE AND BASEMENT CARPARK	Job Number D2024/06	Drawing Number A02.07	Sheet scale A1
42 - 44 NORFOLK ROAD, GREENACRE, 2190, NSW	Scale 1 : 100	Page Total TBC	
Proposed FF Room Calculation	Drawn By MA	Checked By AA	
	Date 03/10/2024	Revision A	



DEVELOPMENT CONTROLS

EXISTING CHILDREN	40
PROPOSED CHILDREN	40
OVERALL CHILDREN	80
REQUIRED OUTDOOR SPACE	80 X 7 = 560 SQM
EXISTING OUTDOOR SPACE	359.328 SQM
BORROWED OUTDOOR SPACE	64.432 SQM
NEW EXISTING OUTDOOR SPACE	294.896 SQM
PROPOSED OUTDOOR SPACE	
GROUND FLOOR	258 SQM
FIRST FLOOR	93 SQM
OVERALL OUTDOOR SPACE	646.896 SQM

DEVELOPMENT CONTROLS



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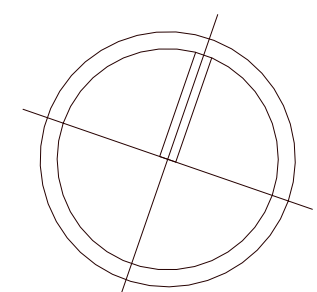
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2190 Australia

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CONSTRUCTION OF A DOUBLE STORY CHILDCARE, FRONT  
FENCE AND BASEMENT CARPARK

42 - 44 NORFOLK ROAD, GREENACRE, 2190, NSW

Proposed Outdoor Requirements

Job Number D2024/06	Drawing Number A02.08	Sheet scale A1
Scale 1 : 200	Page Total TBC	
Drawn By MA	Checked By AA	
Date 03/10/2024	Revision A	



PROPOSED PARKING


CHILD CARE GUIDELINE

REQUIRED OFF-STREET PARKING  
PROPOSED OFF-STREET PARKING  
REQUIRED STAFF OFF-STREET PARKING  
PROPOSED STAFF OFF-STREET PARKING  
PROPOSED VISTOR OFF-STREET PARKING  
  
TOTAL

PROPOSED PARKING

CHILD CARE GUIDELINE

1:4 = 80 / 4 = 20  
20 CAR PARKING SPACES  
11 STAFF  
11 CAR PARKING SPACES  
9 CAR PARKING SPACES  
  
20 CAR PARKING SPACES

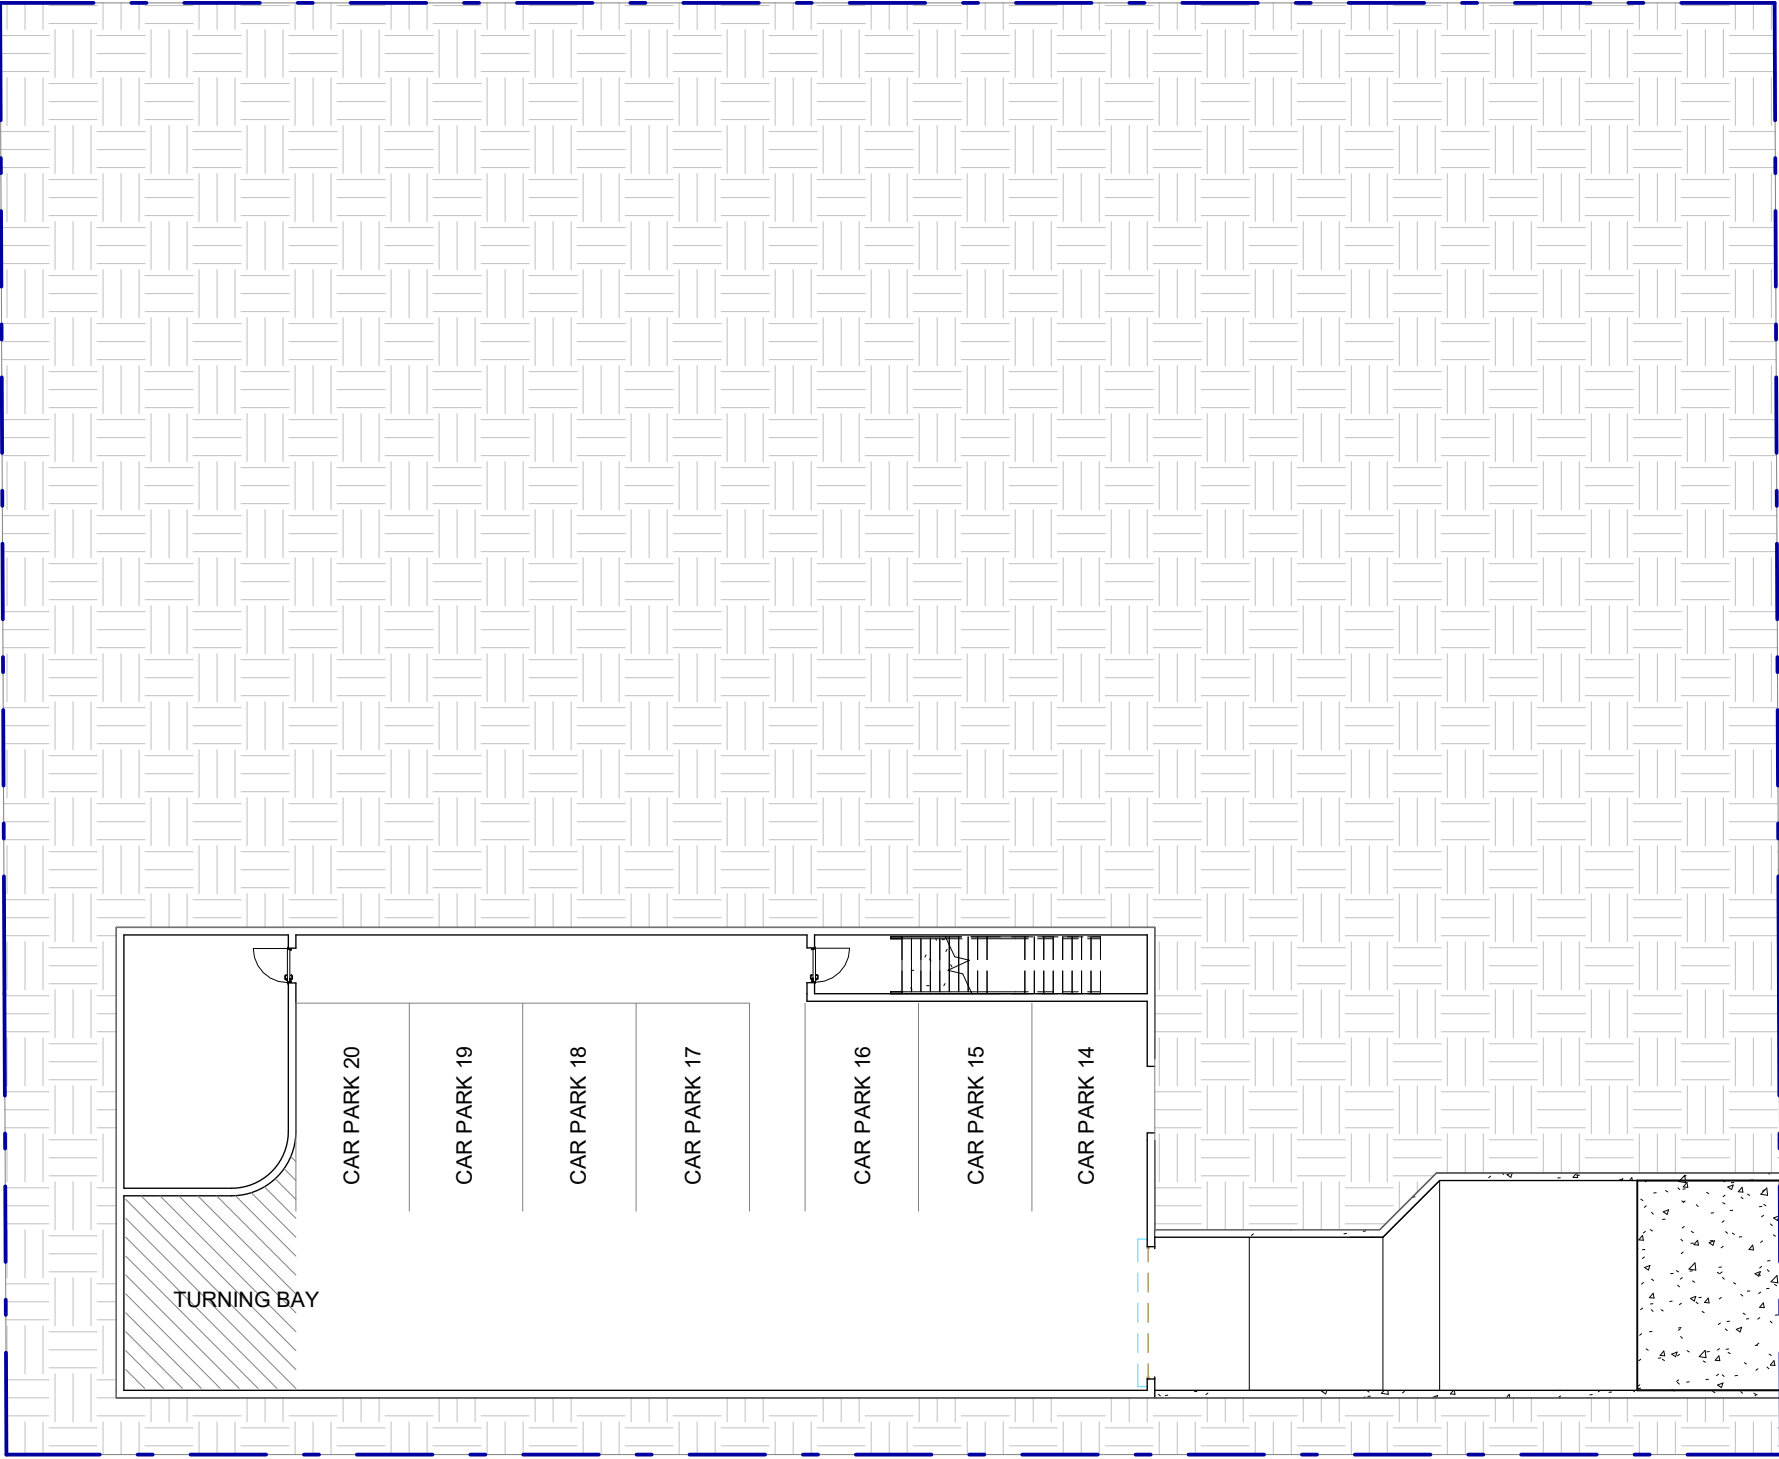

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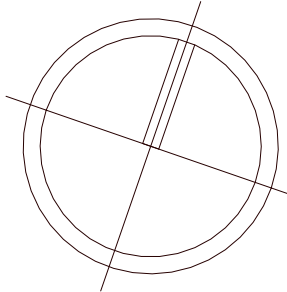
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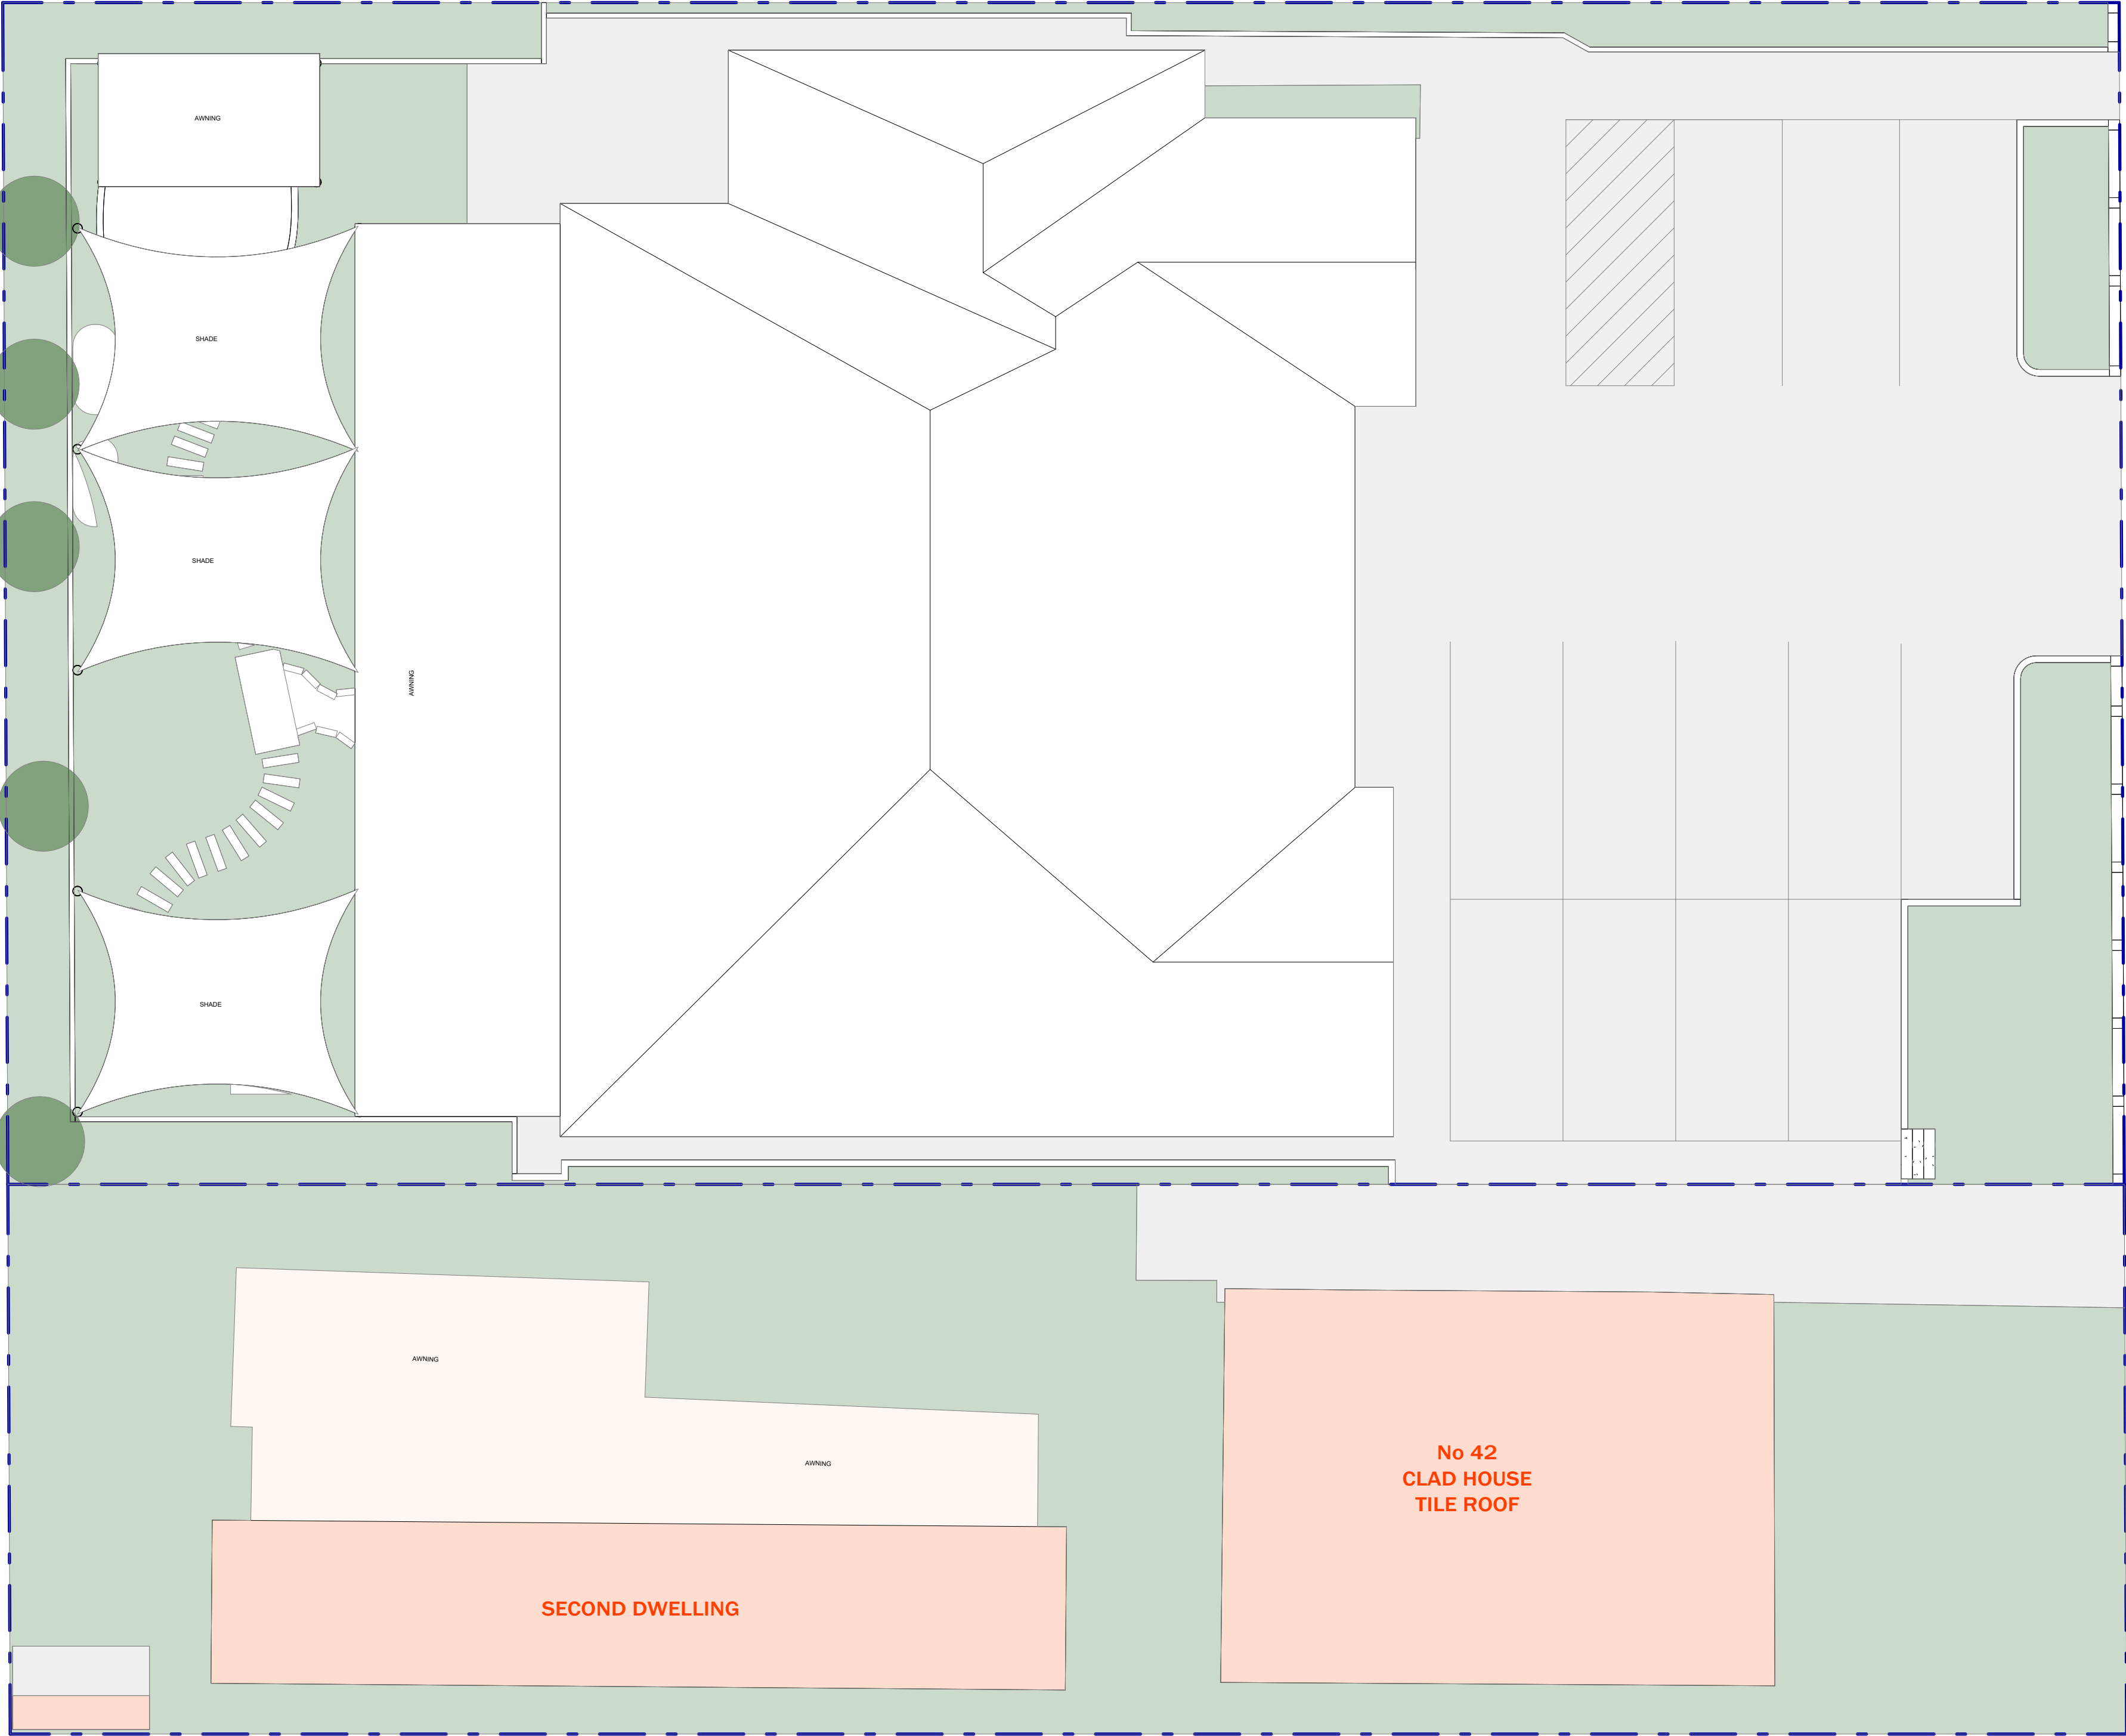
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CONSTRUCTION OF A DOUBLE STORY CHILDCARE, FRONT FENCE AND BASEMENT CARPARK	Job Number D2024/06	Drawing Number A02.09	Sheet scale A1
42 - 44 NORFOLK ROAD, GREENACRE, 2190, NSW	Scale 1 : 200	Page Total TBC	
	Drawn By MA	Checked By AA	
	Date 03/10/2024	Revision A	





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							Scale 1 : 100	Page Total TBC	
							Drawn By MA	Checked By AA	
A	03/10/2024	DA DOCUMENTATION	MA				Date 03/10/2024	Revision A	
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Existing - Door Schedule				
Mark	Phase Created	Height	Width	Count

Ground Floor

D1	Existing	2000	1000	1
D2	Existing	2032	920	20
D4	Existing	2000	1500	1
SD1	Existing	2100	2170	3

Ground Floor: 25

Grand total: 25

Existing - Window Schedule						
Mark	Phase Created	Height	Width	Sill Height	Level	Count

Ground Floor

W1	Existing	1200	610	900	Ground Floor	1
W2	Existing	1800	1090	300	Ground Floor	6
W3	Existing	1800	610	300	Ground Floor	6
W4	Existing	944	610	1156	Ground Floor	1

Ground Floor: 14

Grand total: 14



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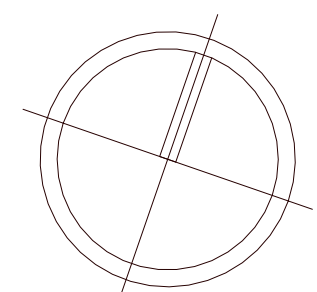
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2190 Australia

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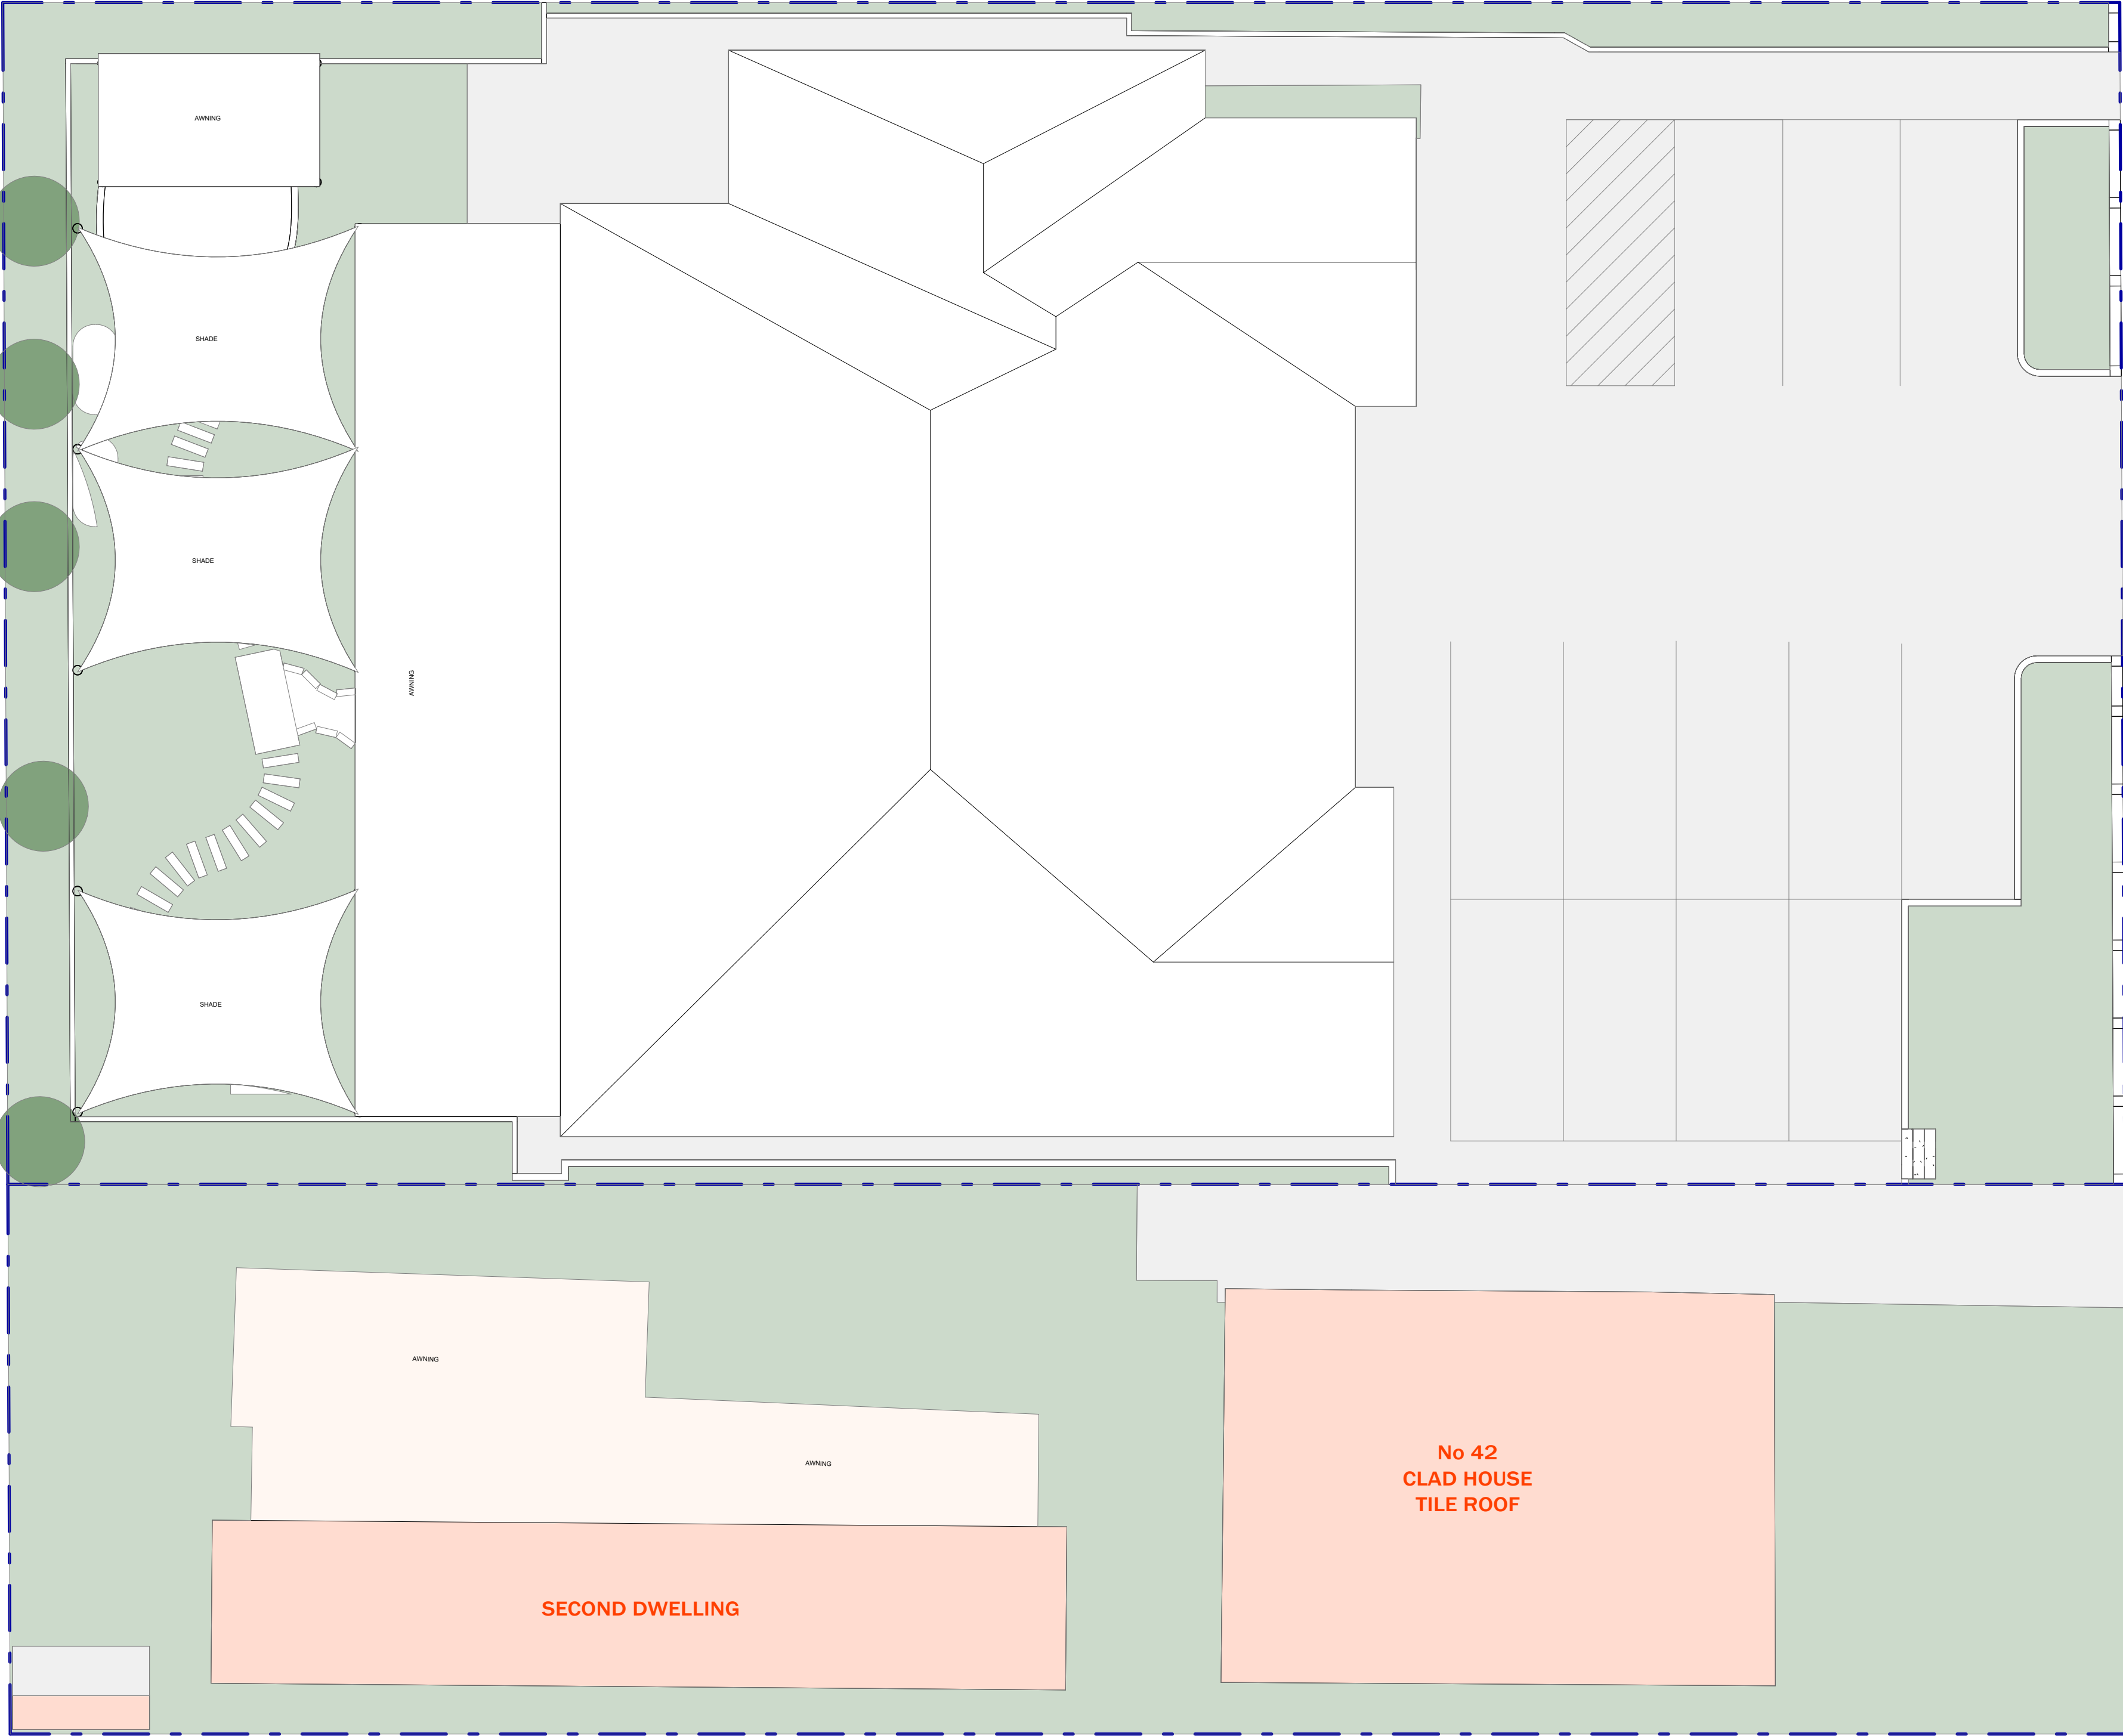
CONSTRUCTION OF A DOUBLE STORY CHILDCARE, FRONT  
FENCE AND BASEMENT CARPARK

42 - 44 NORFOLK ROAD, GREENACRE, 2190, NSW

Existing Ground Floor Plan

Job Number D2024/06	Drawing Number A03.02	Sheet scale A1
Scale 1 : 100	Page Total TBC	
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							Scale 1 : 100	Page Total TBC	
							Drawn By MA	Checked By AA	
A	03/10/2024	DA DOCUMENTATION	MA				Date 03/10/2024	Revision A	
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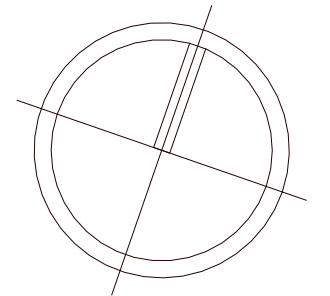
CONSTRUCTION OF A DOUBLE STORY CHILDCARE, FRONT  
FENCE AND BASEMENT CARPARK

42 - 44 NORFOLK ROAD, GREENACRE, 2190, NSW

Proposed Site Plan

Job Number D2024/06	Drawing Number A04.01
Scale 1 : 100	Page Total TBC
Drawn By MA	Checked By AA
Date 03/10/2024	Revision A

Sheet scale  
A1





Proposed - Door Schedule				
Mark	Phase Created	Height	Width	Count


Basement				
FD1	New Construction	2135	920	2
GD1	New Construction	2400	3500	1

Basement: 3				
Ground Floor				
D2	New Construction	2032	920	6
D3	New Construction	1200	2500	1
D4	New Construction	2000	1500	1
FD1	New Construction	2135	920	2
SD2	New Construction	2100	4000	1

Ground Floor: 11				
First Floor				
D2	New Construction	2032	920	5
D4	New Construction	2000	1500	1
FD1	New Construction	2135	920	1
SD2	New Construction	2100	4000	1

D2	New Construction	2032	920	5
D4	New Construction	2000	1500	1
FD1	New Construction	2135	920	1
SD2	New Construction	2100	4000	1

Grand total: 22

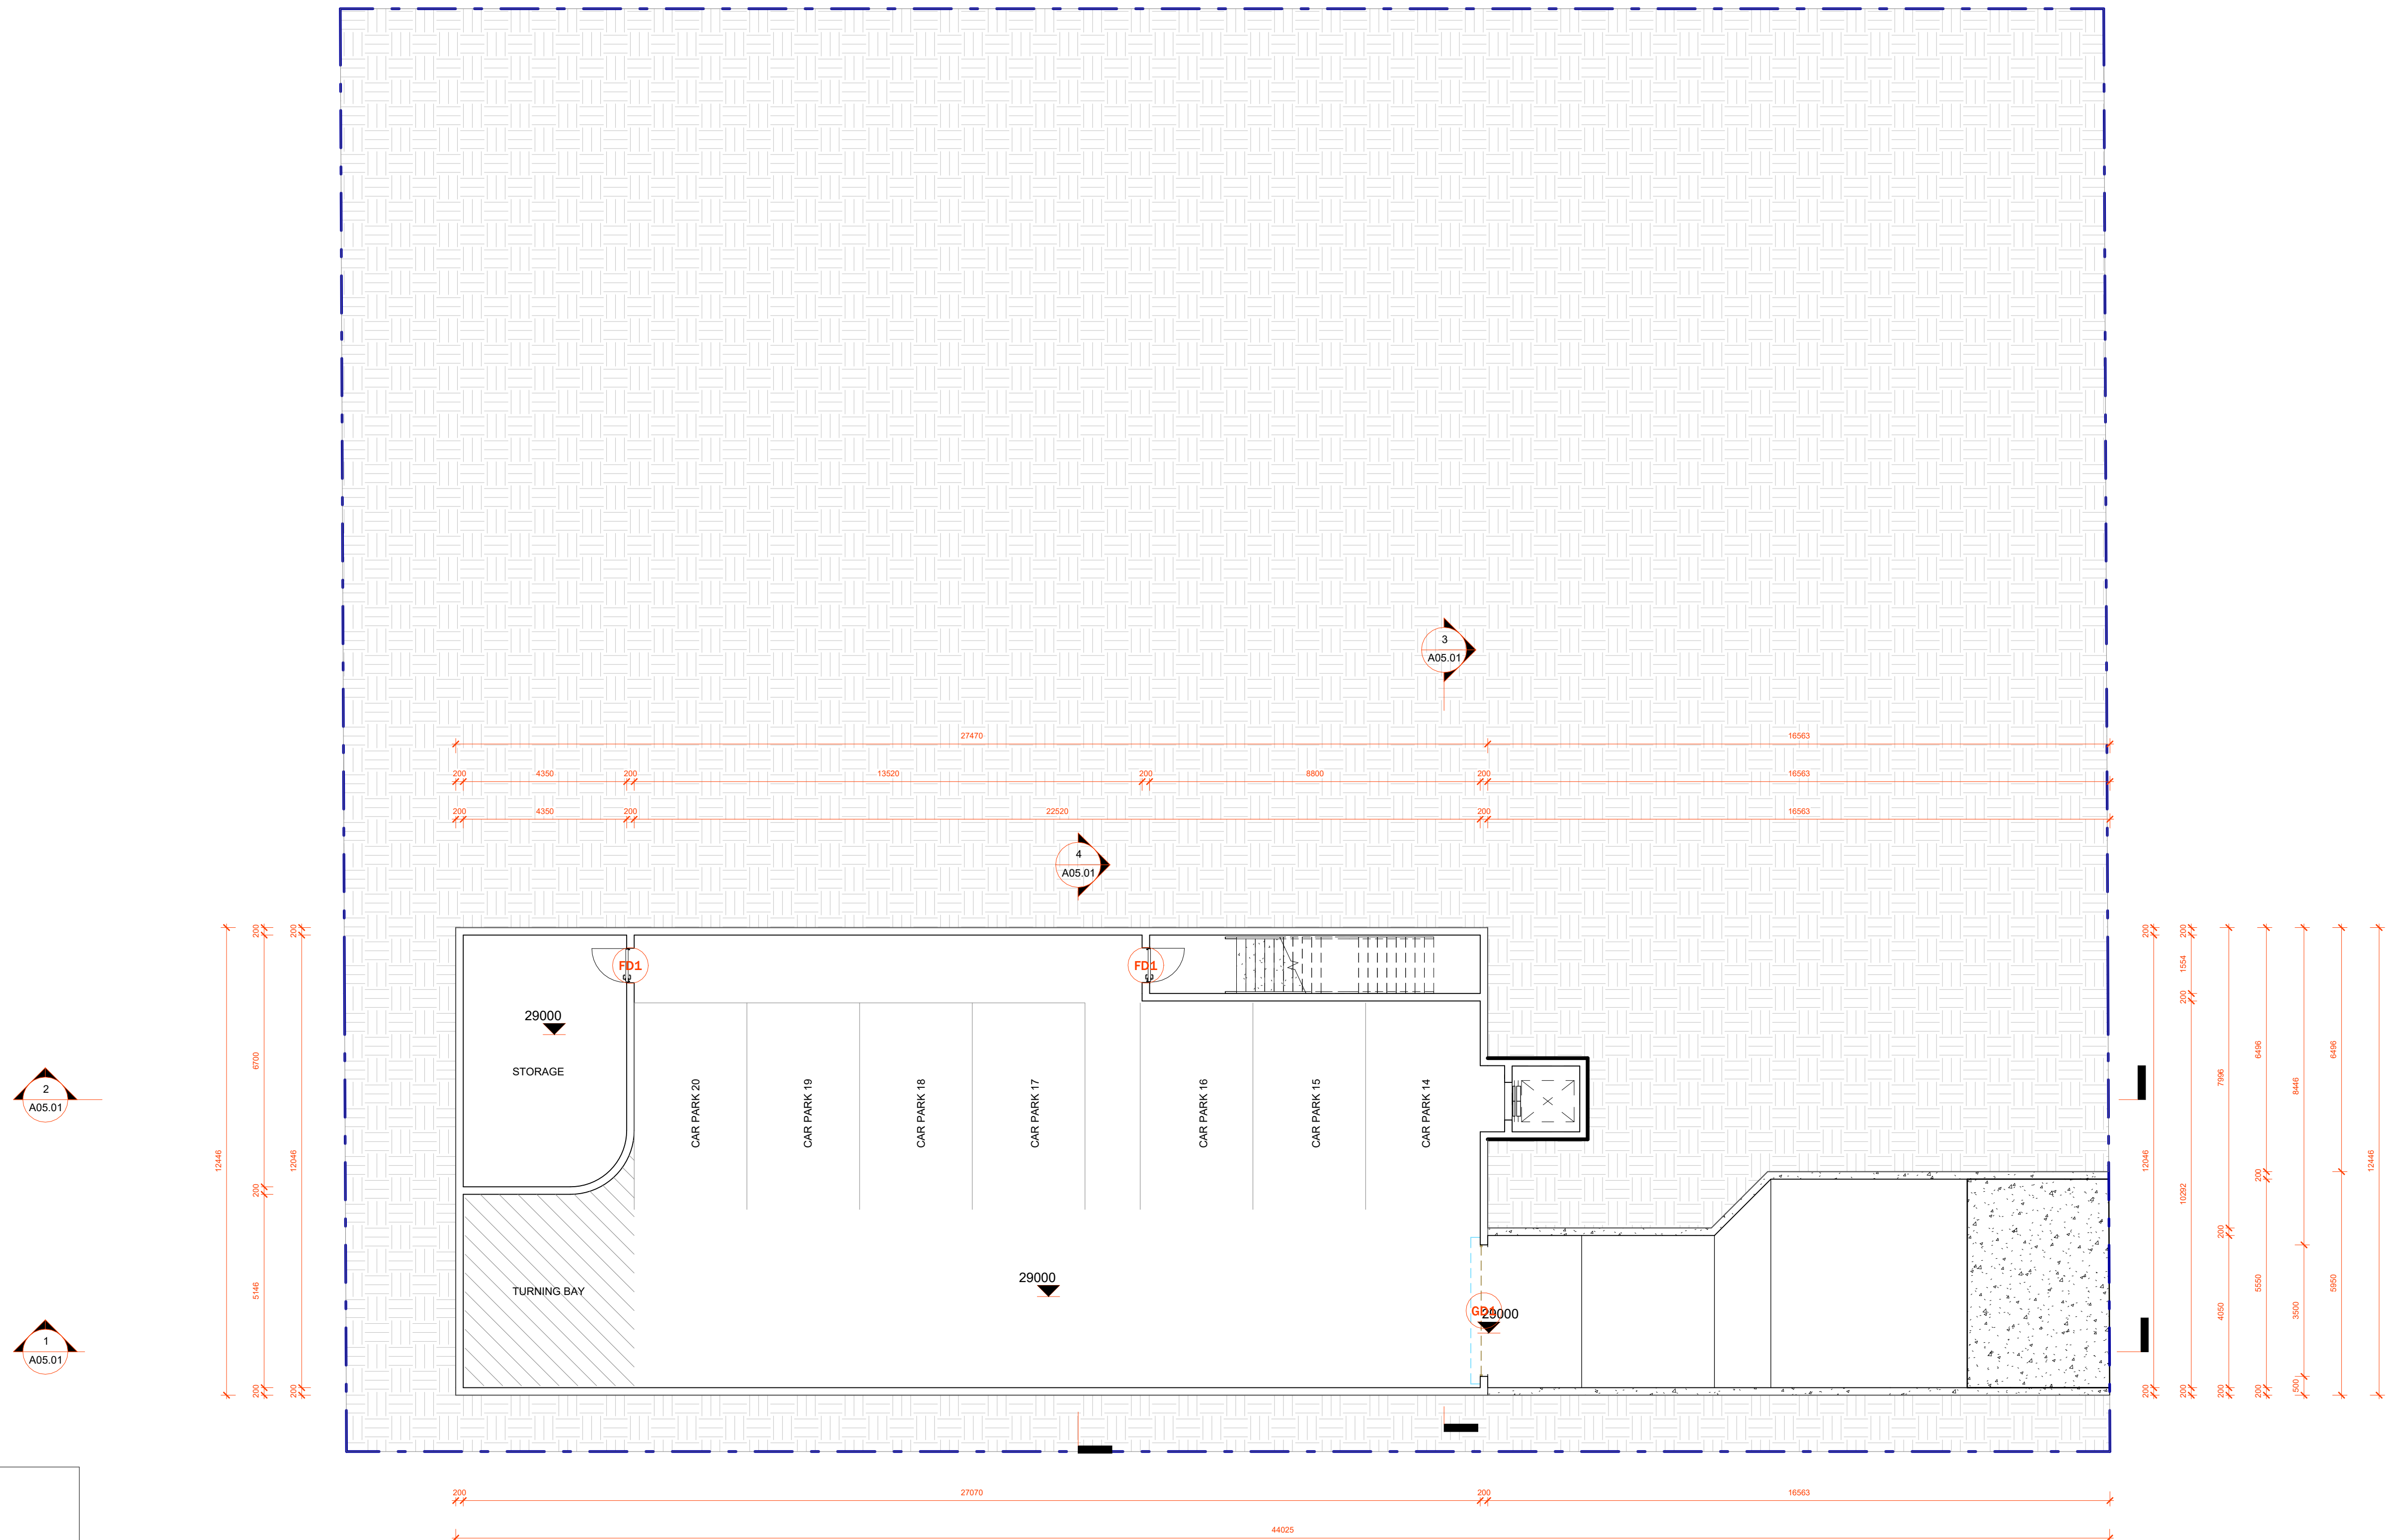

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							42 - 44 NORFOLK ROAD, GREENACRE, 2190, NSW	Scale 1 : 100	Page Total TBC		
A	03/10/2024	DA DOCUMENTATION	MA				 <p>Waratah Group</p>	Proposed Basement	Drawn By MA		Checked By AA
REV	DATE	DESCRIPTION	BY						Date 03/10/2024		Revision A



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## CONSTRUCTION OF A DOUBLE STORY CHILDCARE, FROM FENCE AND BASEMENT CARPARK

42 - 44 NORFOLK ROAD, GREENACRE, 2190, NSW

## Proposed Basement

Job Number  
D2024/06

Scale  
1 : 100

Drawn By  
MA

Date  
03/10/202

Drawing Number  
**A04.02**

Page Total


TBC

Checked By  
AA

Revision

sheet scale

A1

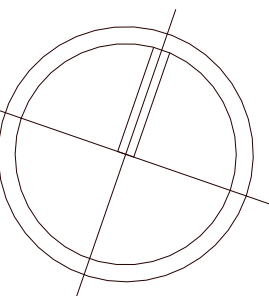



Basement				
FD1	New Construction	2135	920	2
GD1	New Construction	2400	3500	1

Basement: 3

Ground Floor				
D2	New Construction	2032	920	6
D3	New Construction	1200	2500	1
D4	New Construction	2000	1500	1
FD1	New Construction	2135	920	2
SD2	New Construction	2100	4000	1

Ground Floor: 11

First Floor				
D2	New Construction	2032	920	5
D4	New Construction	2000	1500	1
FD1	New Construction	2135	920	1
SD2	New Construction	2100	4000	1

First Floor: 8

Grand total: 22


Ground Floor						
IW1	New Construction	1200	1800	1100	Ground Floor	3
W1	New Construction	1200	610	900	Ground Floor	9
W3	New Construction	1800	610	300	Ground Floor	1

Ground Floor: 13

First Floor						
IW1	New Construction	1200	1800	1100	First Floor	1
W1	New Construction	1200	610	1100	First Floor	4

First Floor: 5

Grand total: 18

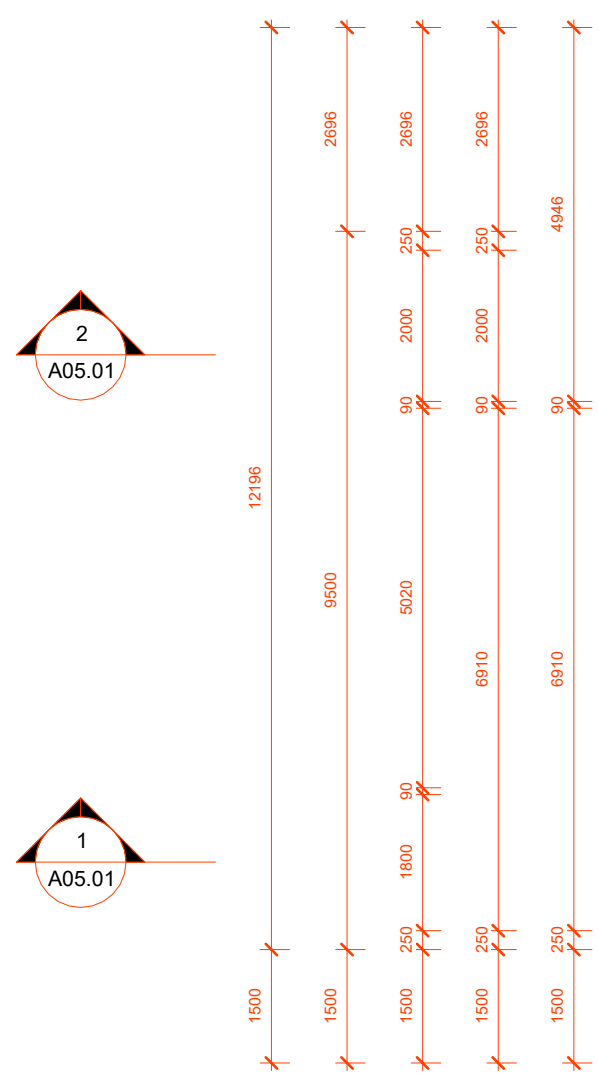

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## CONSTRUCTION OF A DOUBLE STORY CHILDCARE, FRONT FENCE AND BASEMENT CARPARK

42 - 44 NORFOLK ROAD, GREENACRE, 2190, NSW

## Proposed Ground Floor Plan

Job Number  
D2024/06

Scale  
1 : 100

Drawn By  
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Date 03/10/2024


Drawing Number  
**A04.03**

Page Total

Checked By

Revision

Sheet scale

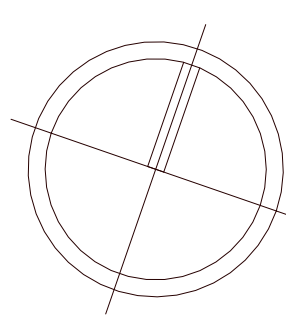



Proposed - Door Schedule				
Mark	Phase Created	Height	Width	Count

FD1	New Construction	2135	920	2
GD1	New Construction	2400	3500	1

## Ground Floor

D2	New Construction	2032	920	6
D3	New Construction	1200	2500	1
D4	New Construction	2000	1500	1
FD1	New Construction	2135	920	2
SD2	New Construction	2100	4000	1

## First Floor

D2	New Construction	2032	920	5
D4	New Construction	2000	1500	1
FD1	New Construction	2135	920	1
SD2	New Construction	2100	4000	1


Grand total: 22

Proposed - Window Schedule						
Mark	Phase Created	Height	Width	Sill Height	Level	Count

IW1	New Construction	1200	1800	1100	Ground Floor	3
W1	New Construction	1200	610	900	Ground Floor	9
W3	New Construction	1800	610	300	Ground Floor	1

First Floor						
IW1	New Construction	1200	1800	1100	First Floor	1
W1	New Construction	1200	610	1100	First Floor	4

Grand total: 18

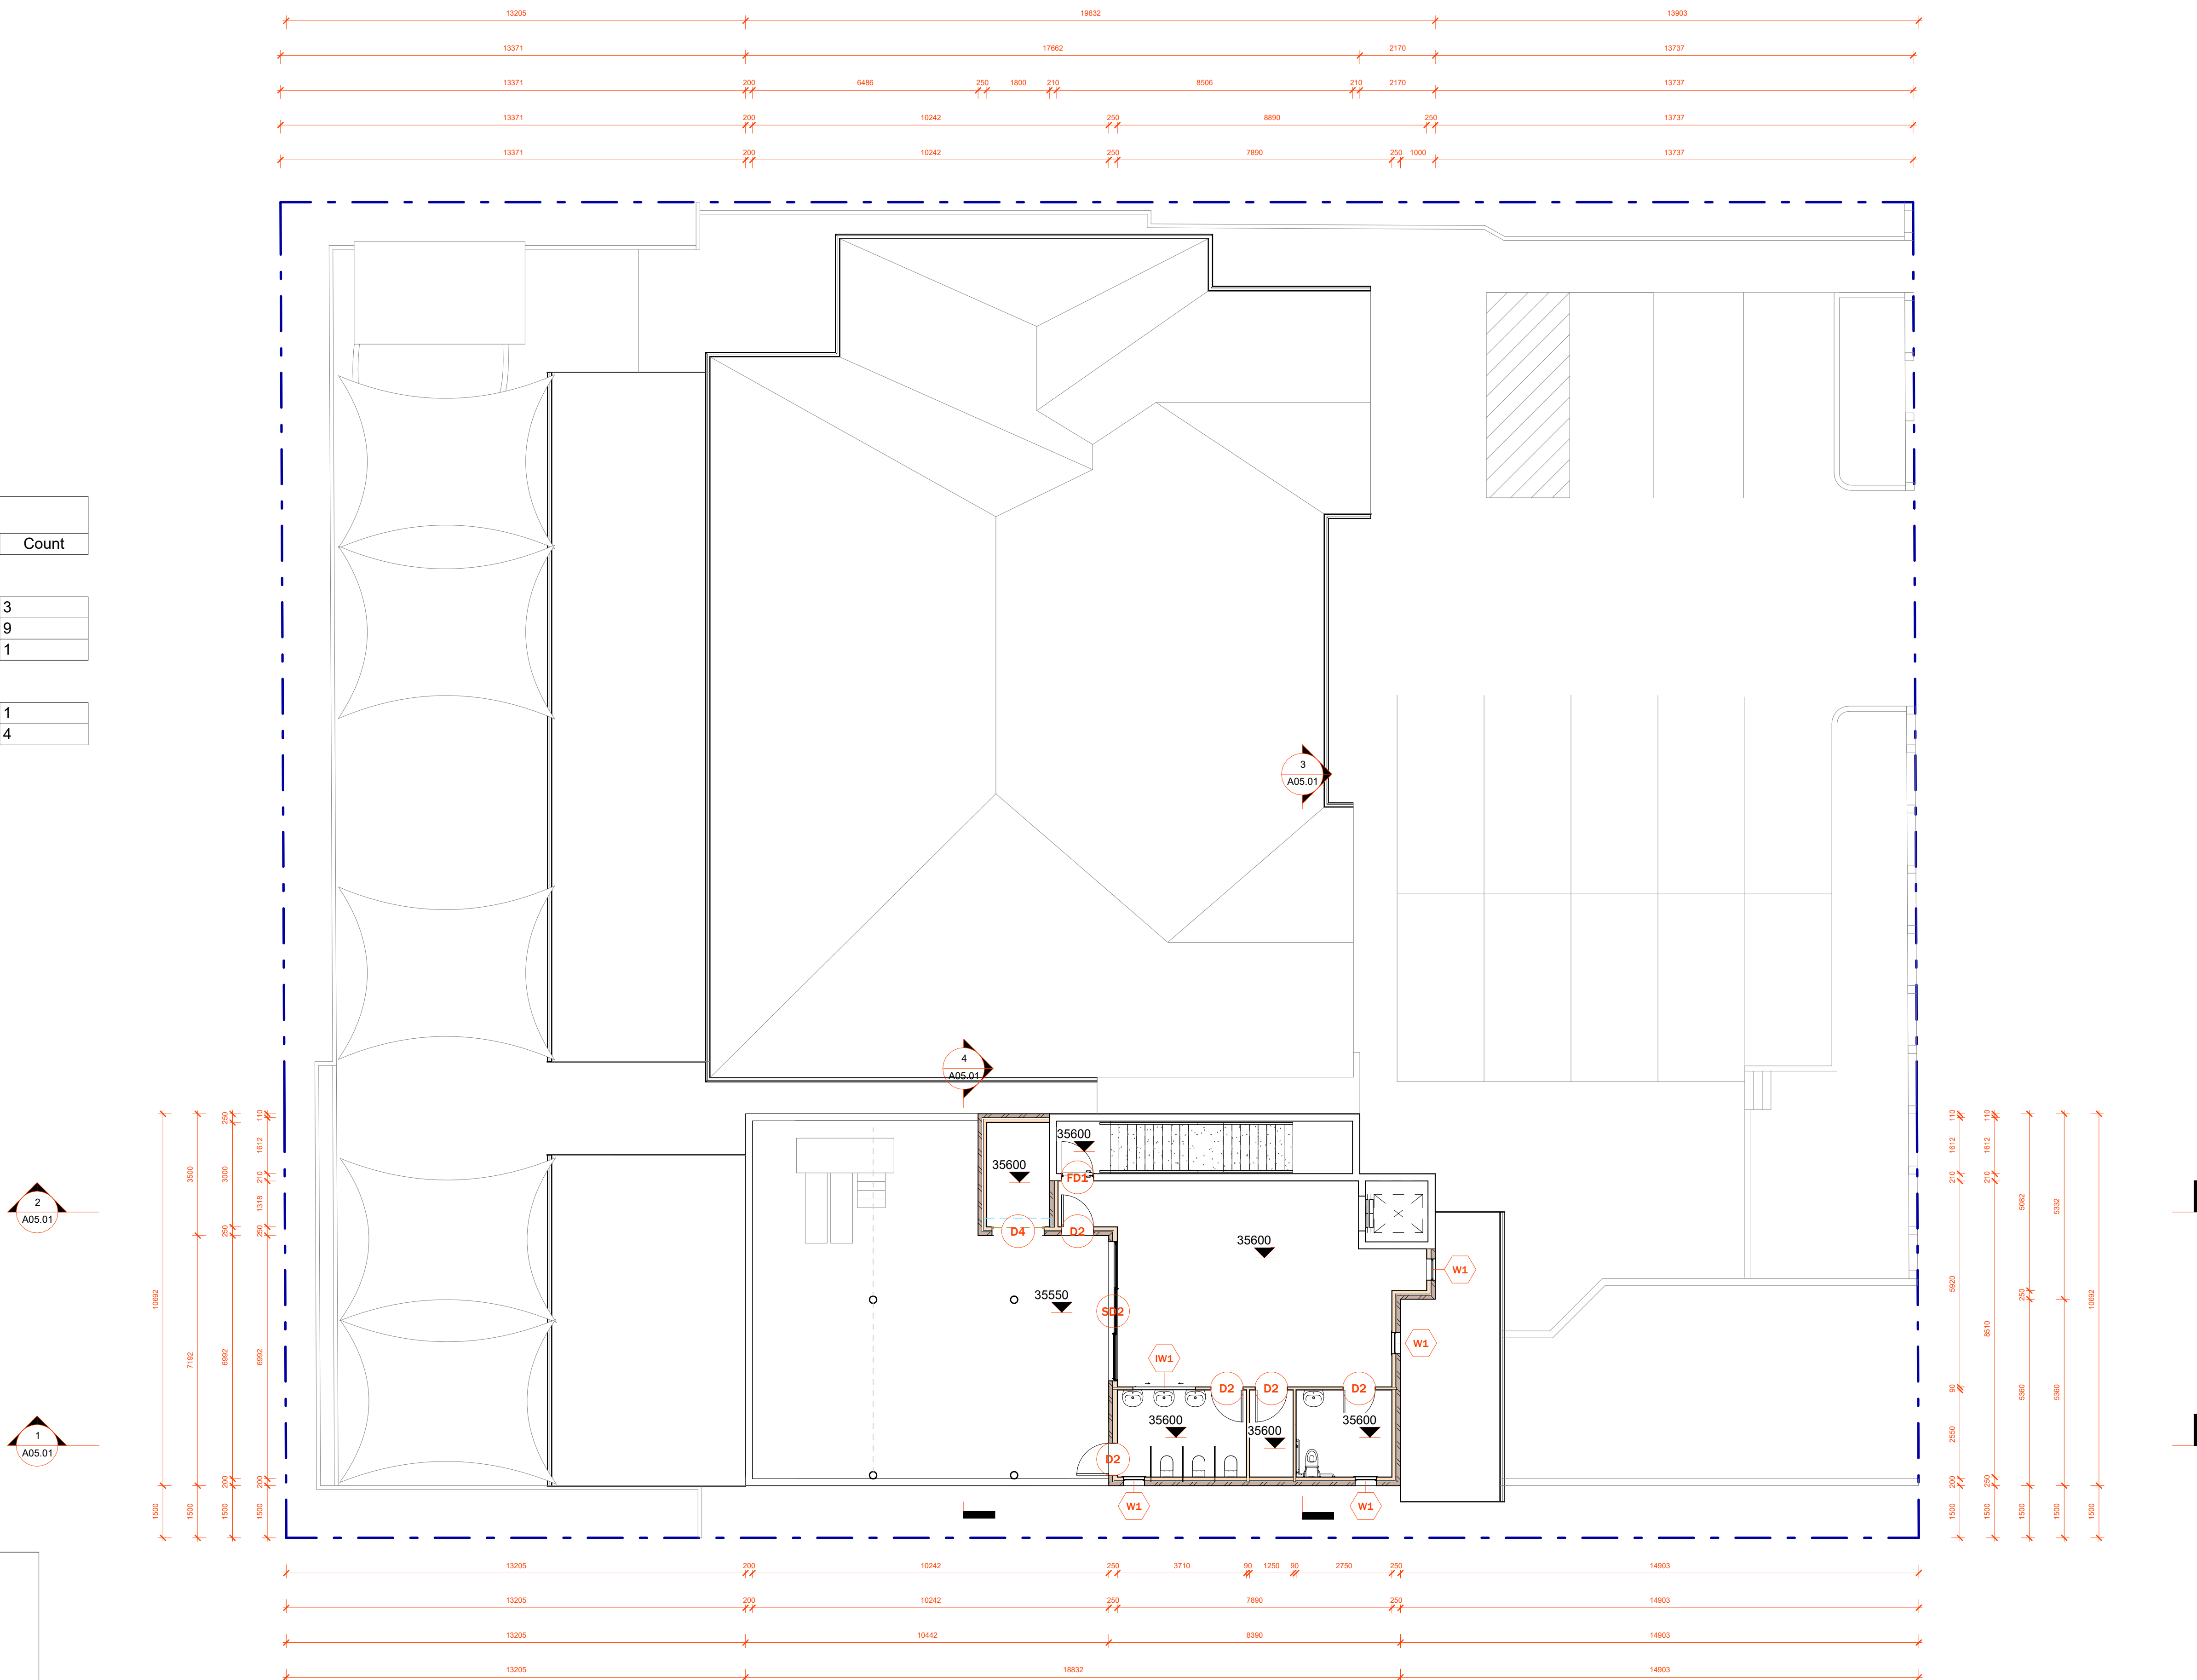

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## CONSTRUCTION OF A DOUBLE STORY CHILDCARE, FRONT FENCE AND BASEMENT CARPARK

42 - 44 NORFOLK ROAD, GREENACRE, 2190, NSW

## Proposed First Floor Plan

Job Number  
D2024/06

1 : 100

Drawn By

MA

Date \_\_\_\_\_


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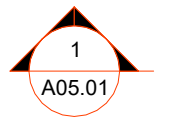
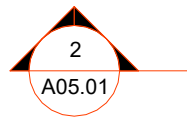
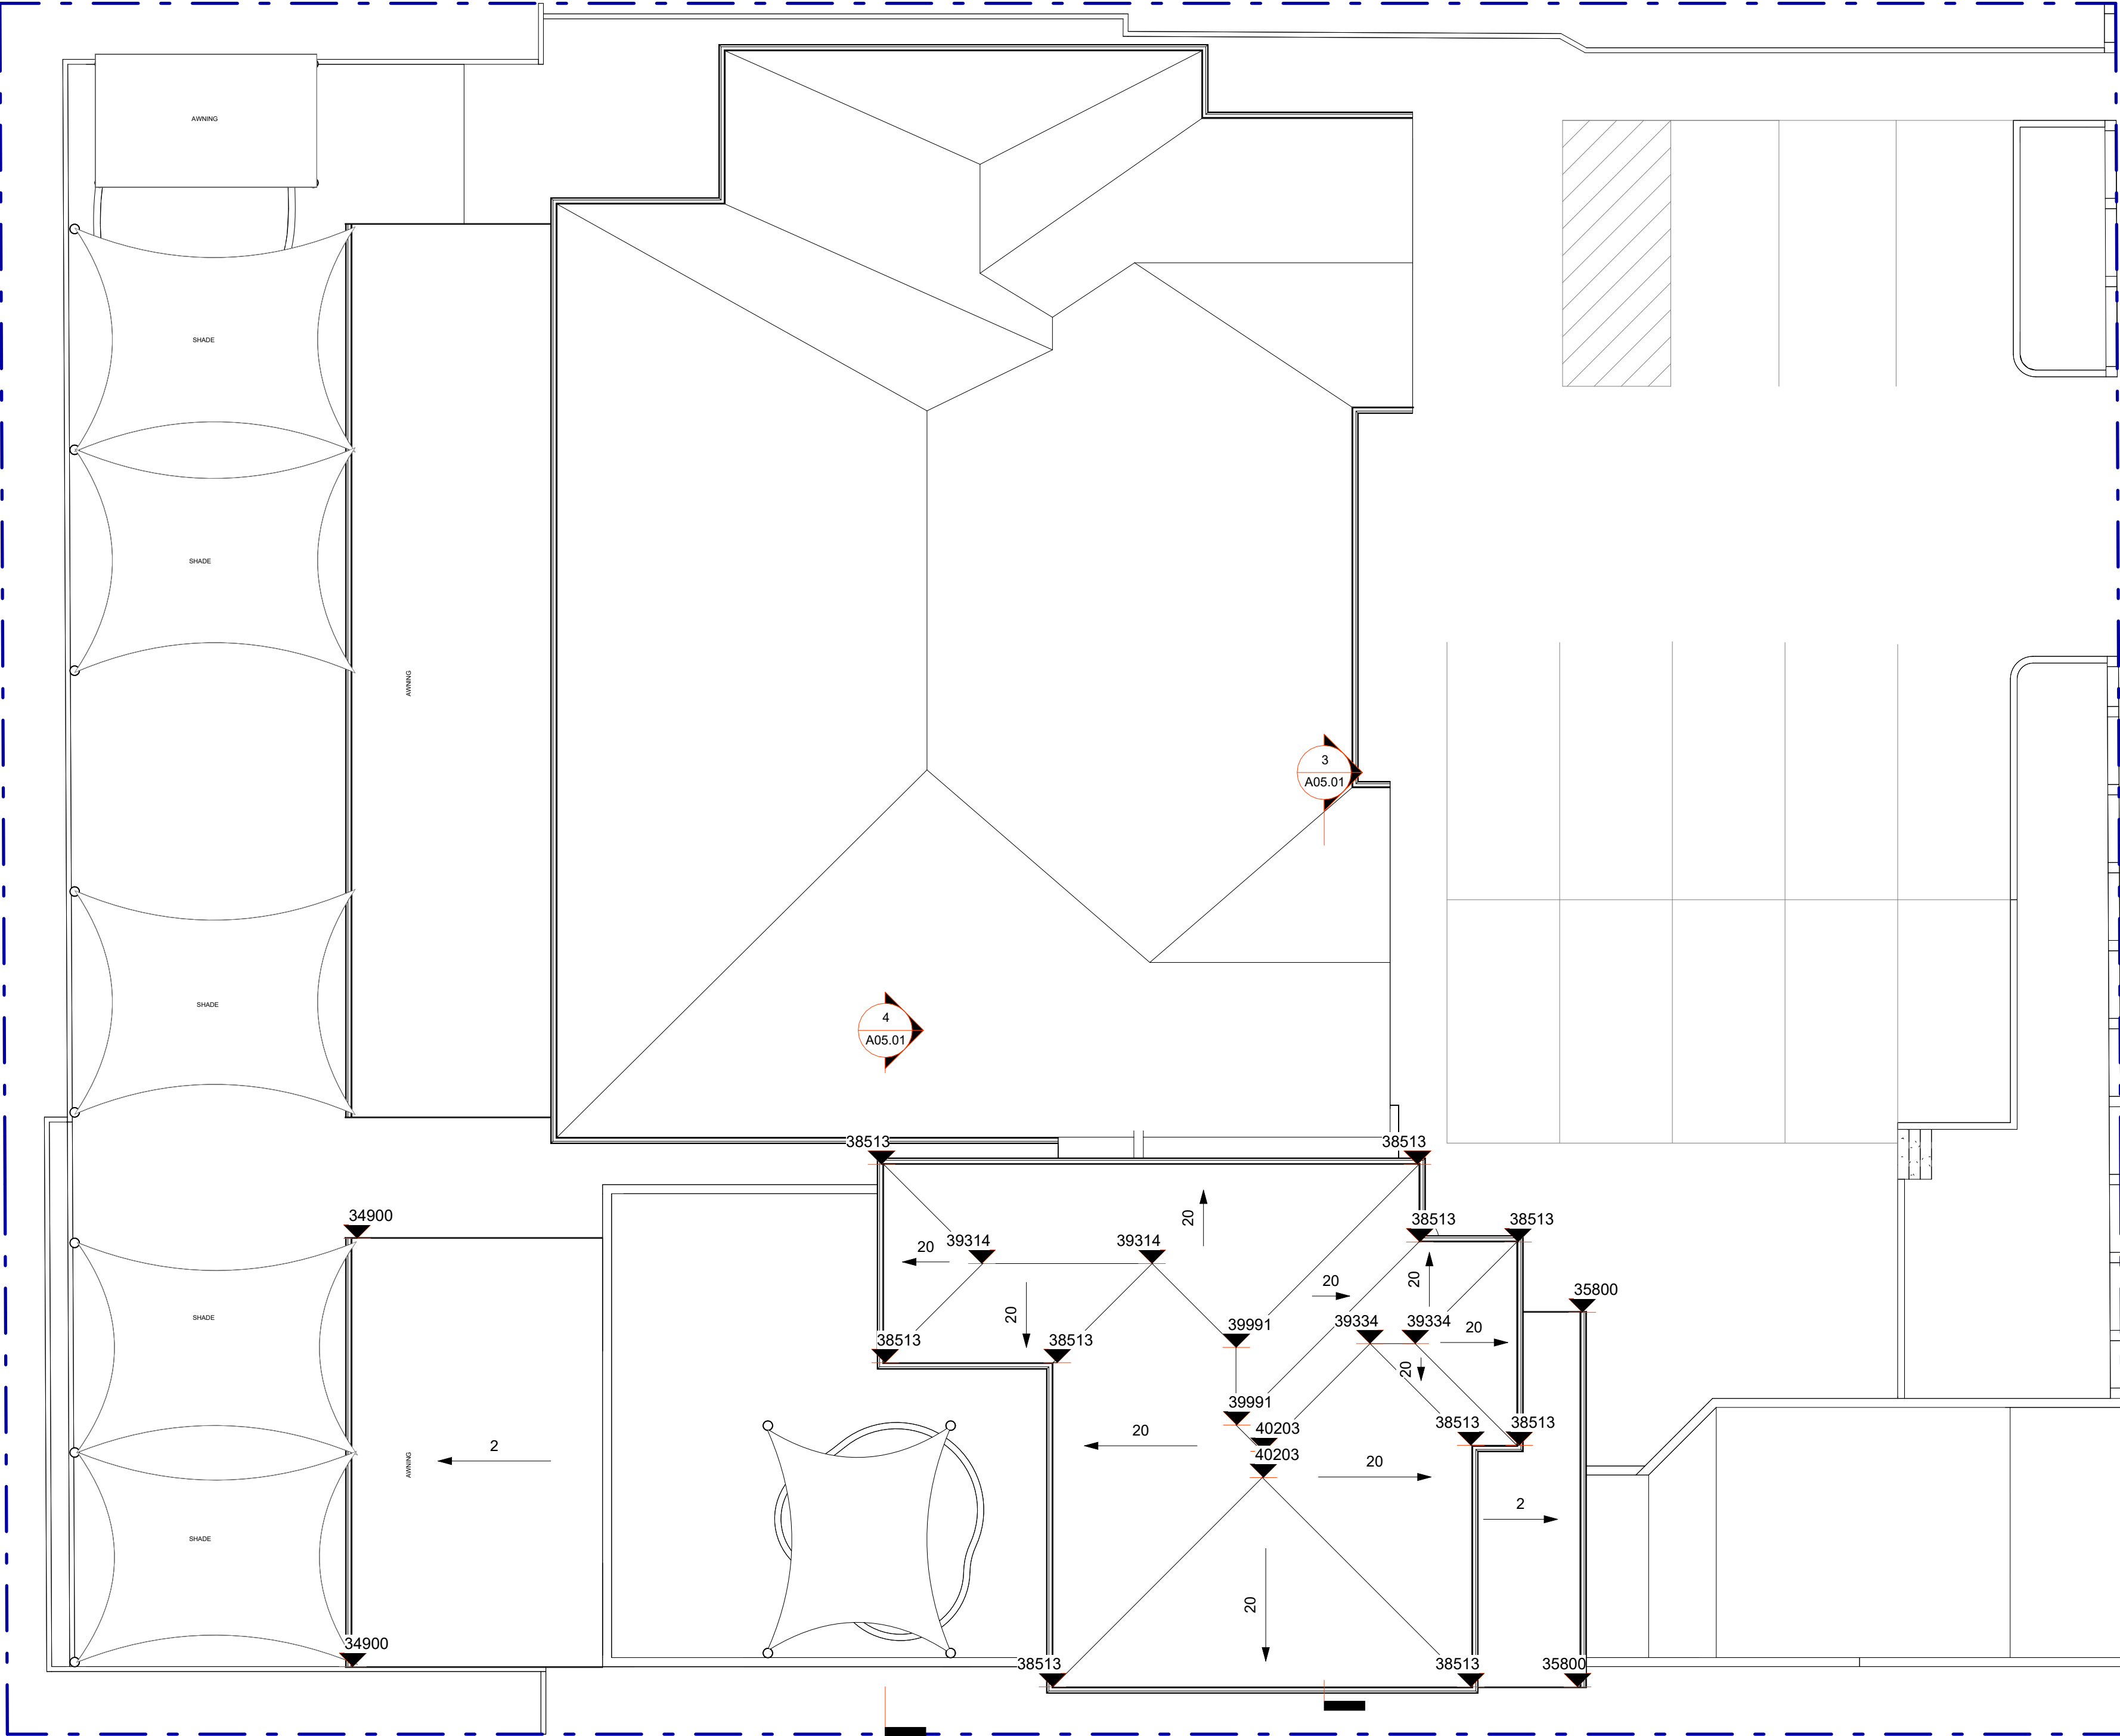
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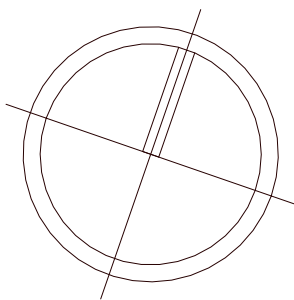
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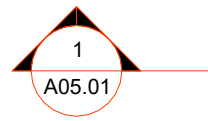
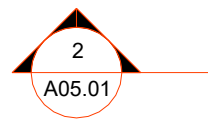
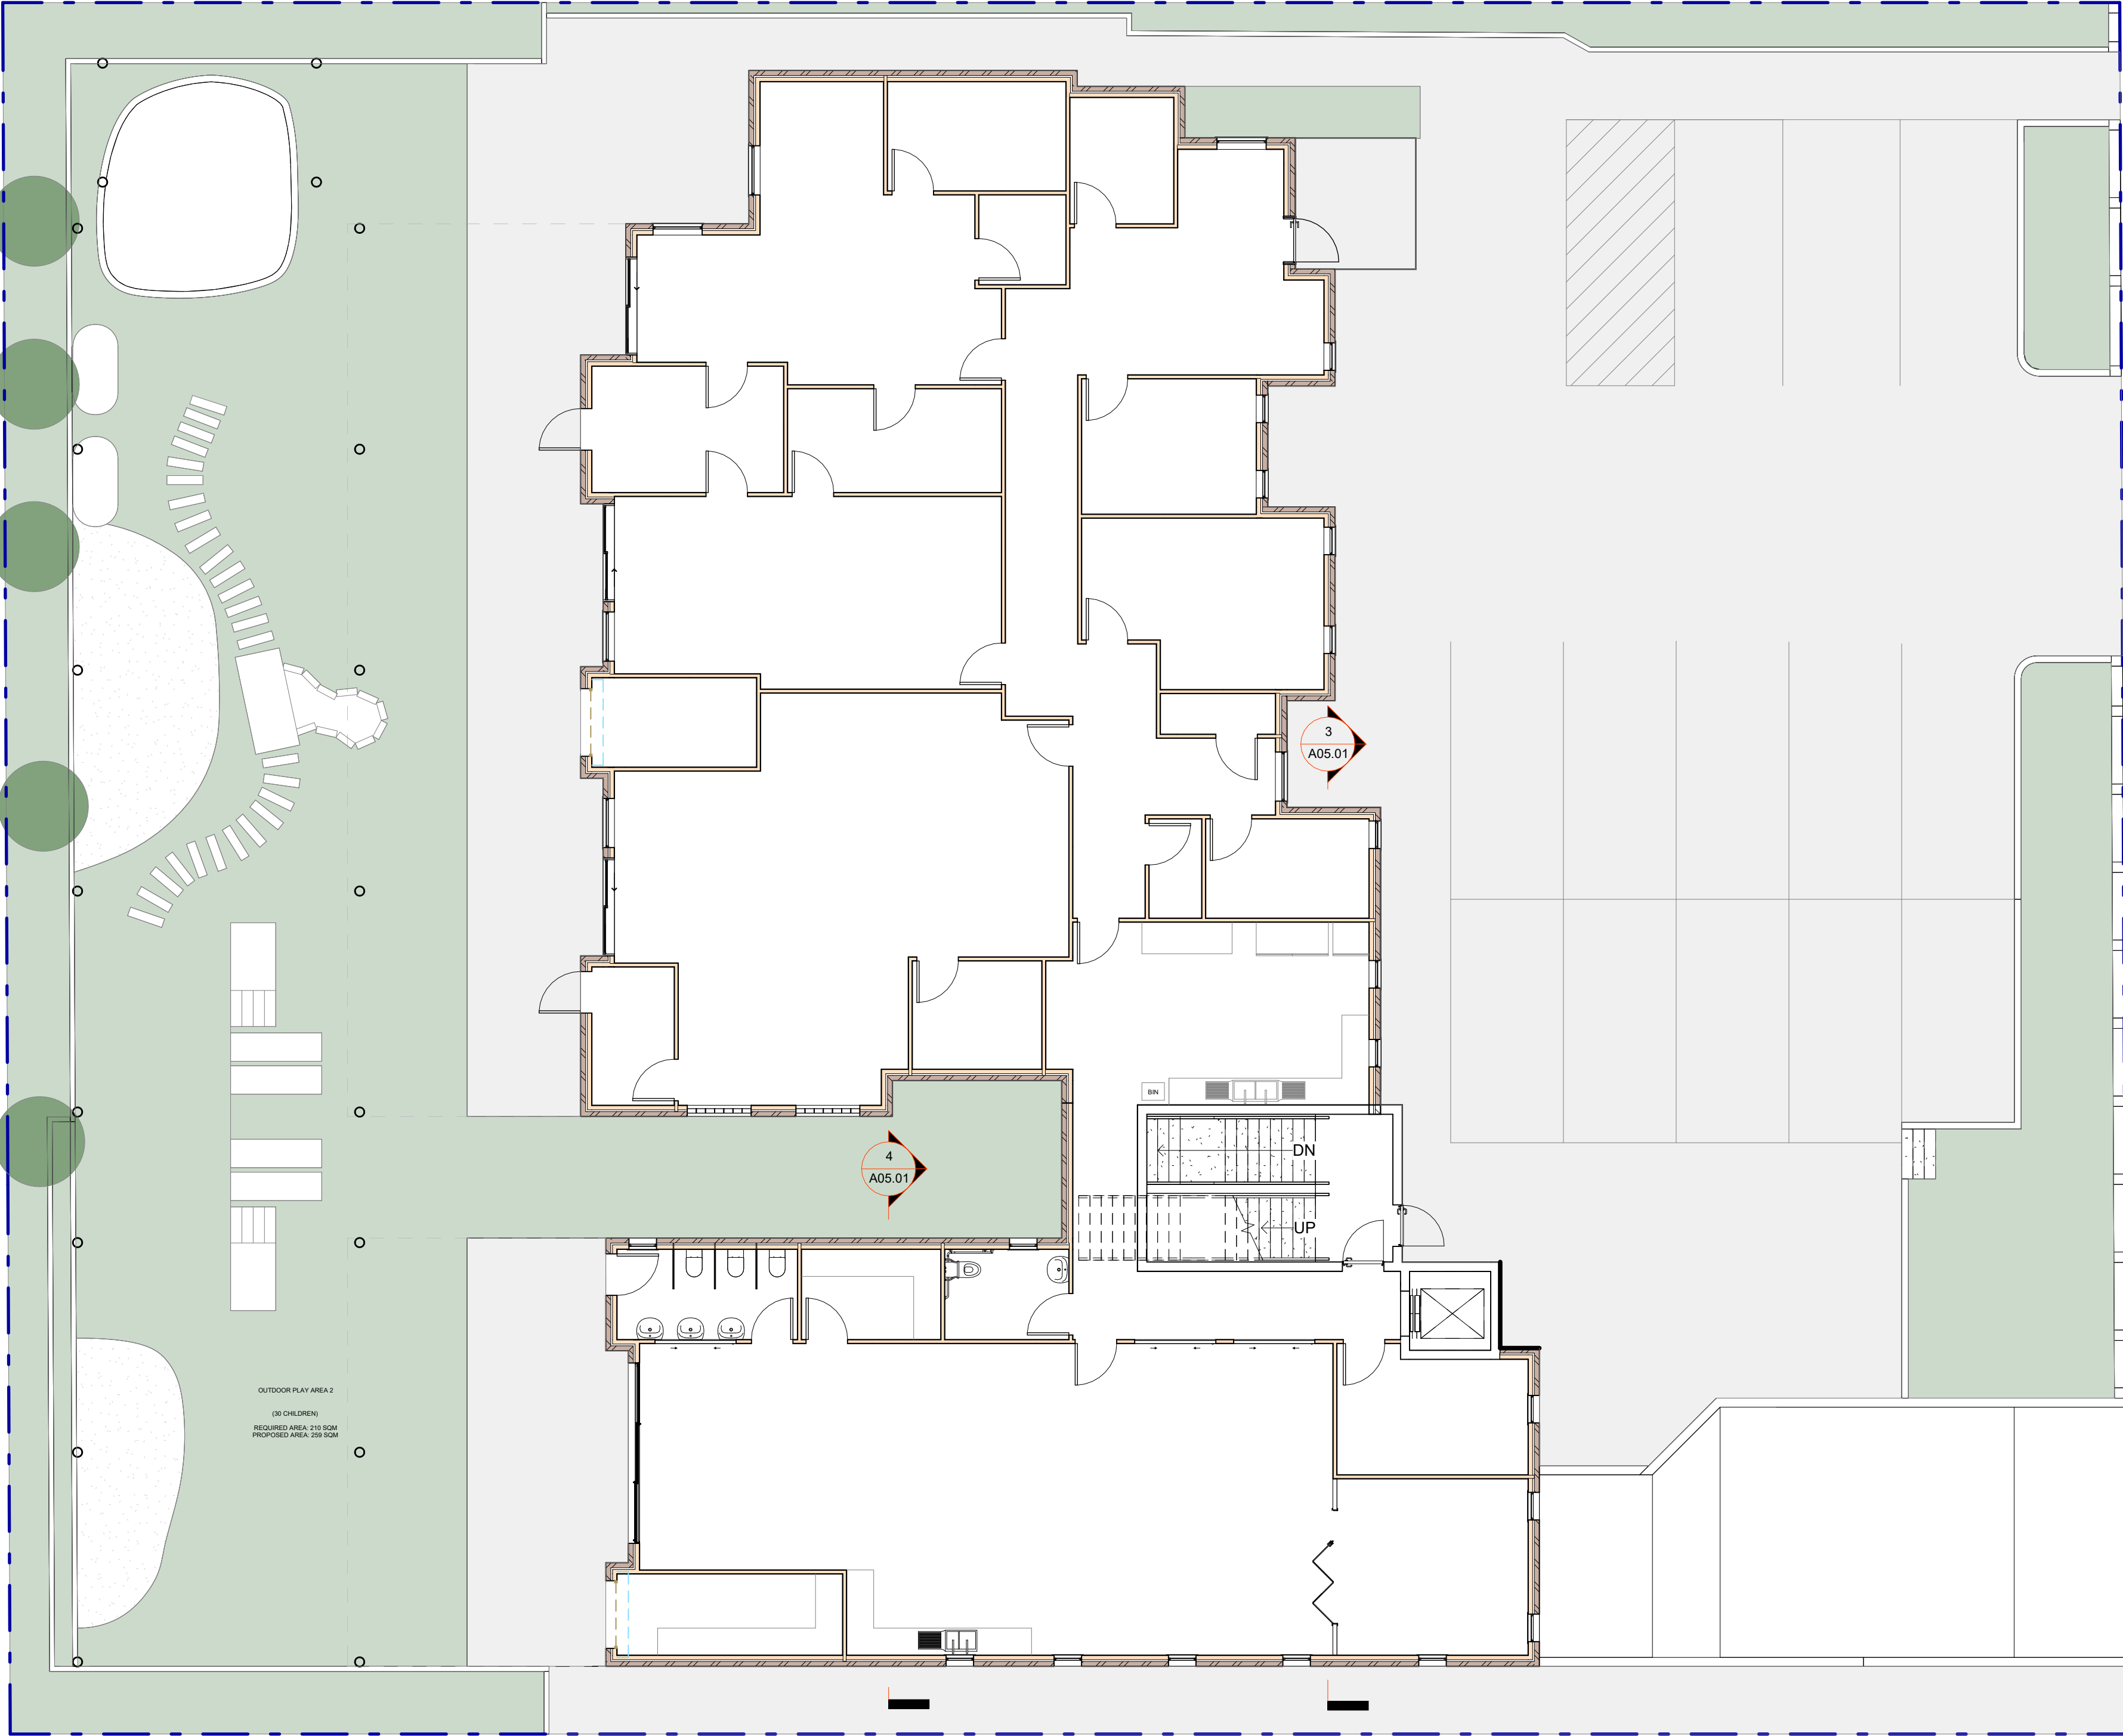
CONSTRUCTION OF A DOUBLE STORY CHILDCARE, FRONT  
FENCE AND BASEMENT CARPARK

42 - 44 NORFOLK ROAD, GREENACRE, 2190, NSW

Proposed Roof Plan

Job Number D2024/06	Drawing Number A04.05	Sheet scale A1
Scale 1 : 100	Page Total TBC	
Drawn By MA	Checked By AA	
Date 03/10/2024	Revision A	



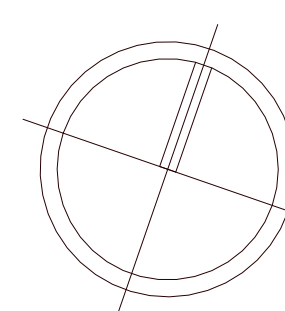

OUTDOOR PLAY AREA 2  
(OR CHILDREN)  
REQUIRED AREA: 215 SQM  
PROPOSED AREA: 225 SQM



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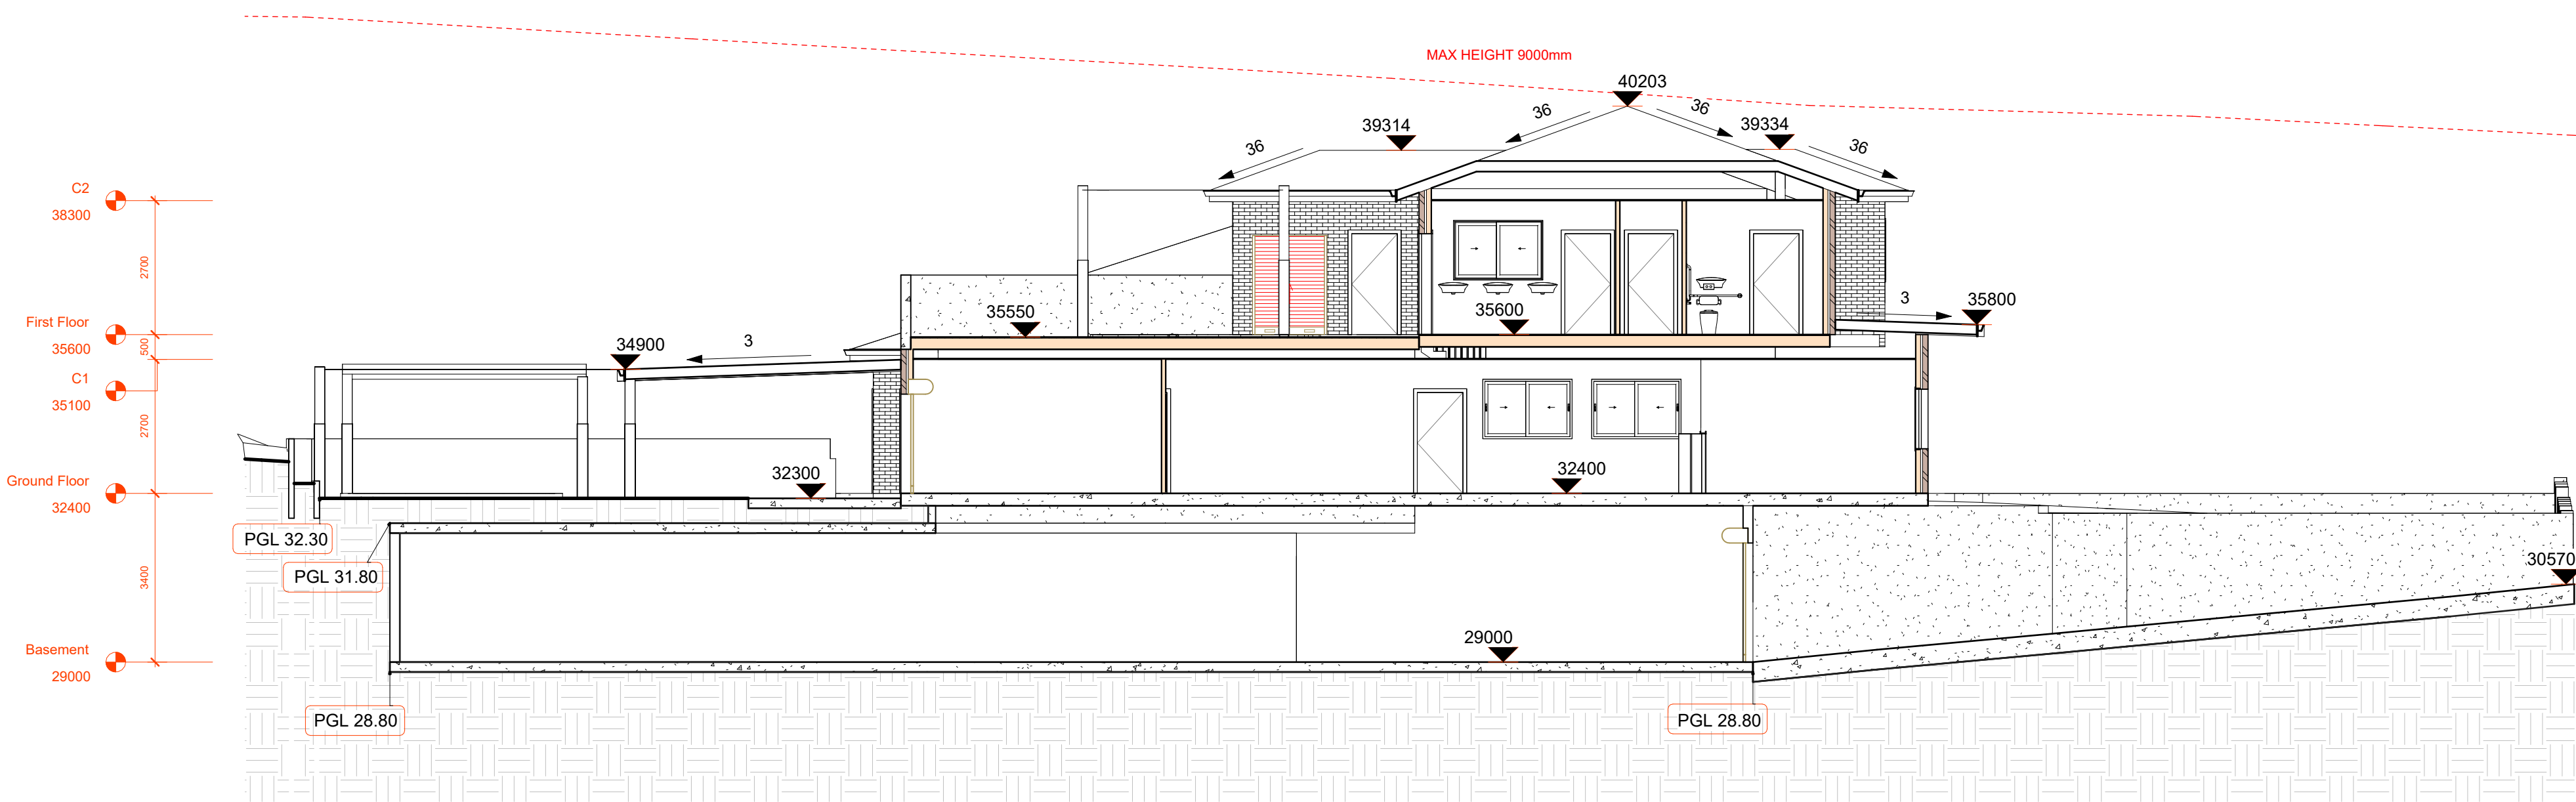
CONSTRUCTION OF A DOUBLE STORY CHILDCARE, FRONT  
FENCE AND BASEMENT CARPARK

42 - 44 NORFOLK ROAD, GREENACRE, 2190, NSW


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Job Number D2024/06	Drawing Number A04.06	Sheet scale A1
Scale 1 : 100	Page Total TBC	
Drawn By MA	Checked By AA	
Date 03/10/2024	Revision A	







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SCALE: 1 : 100

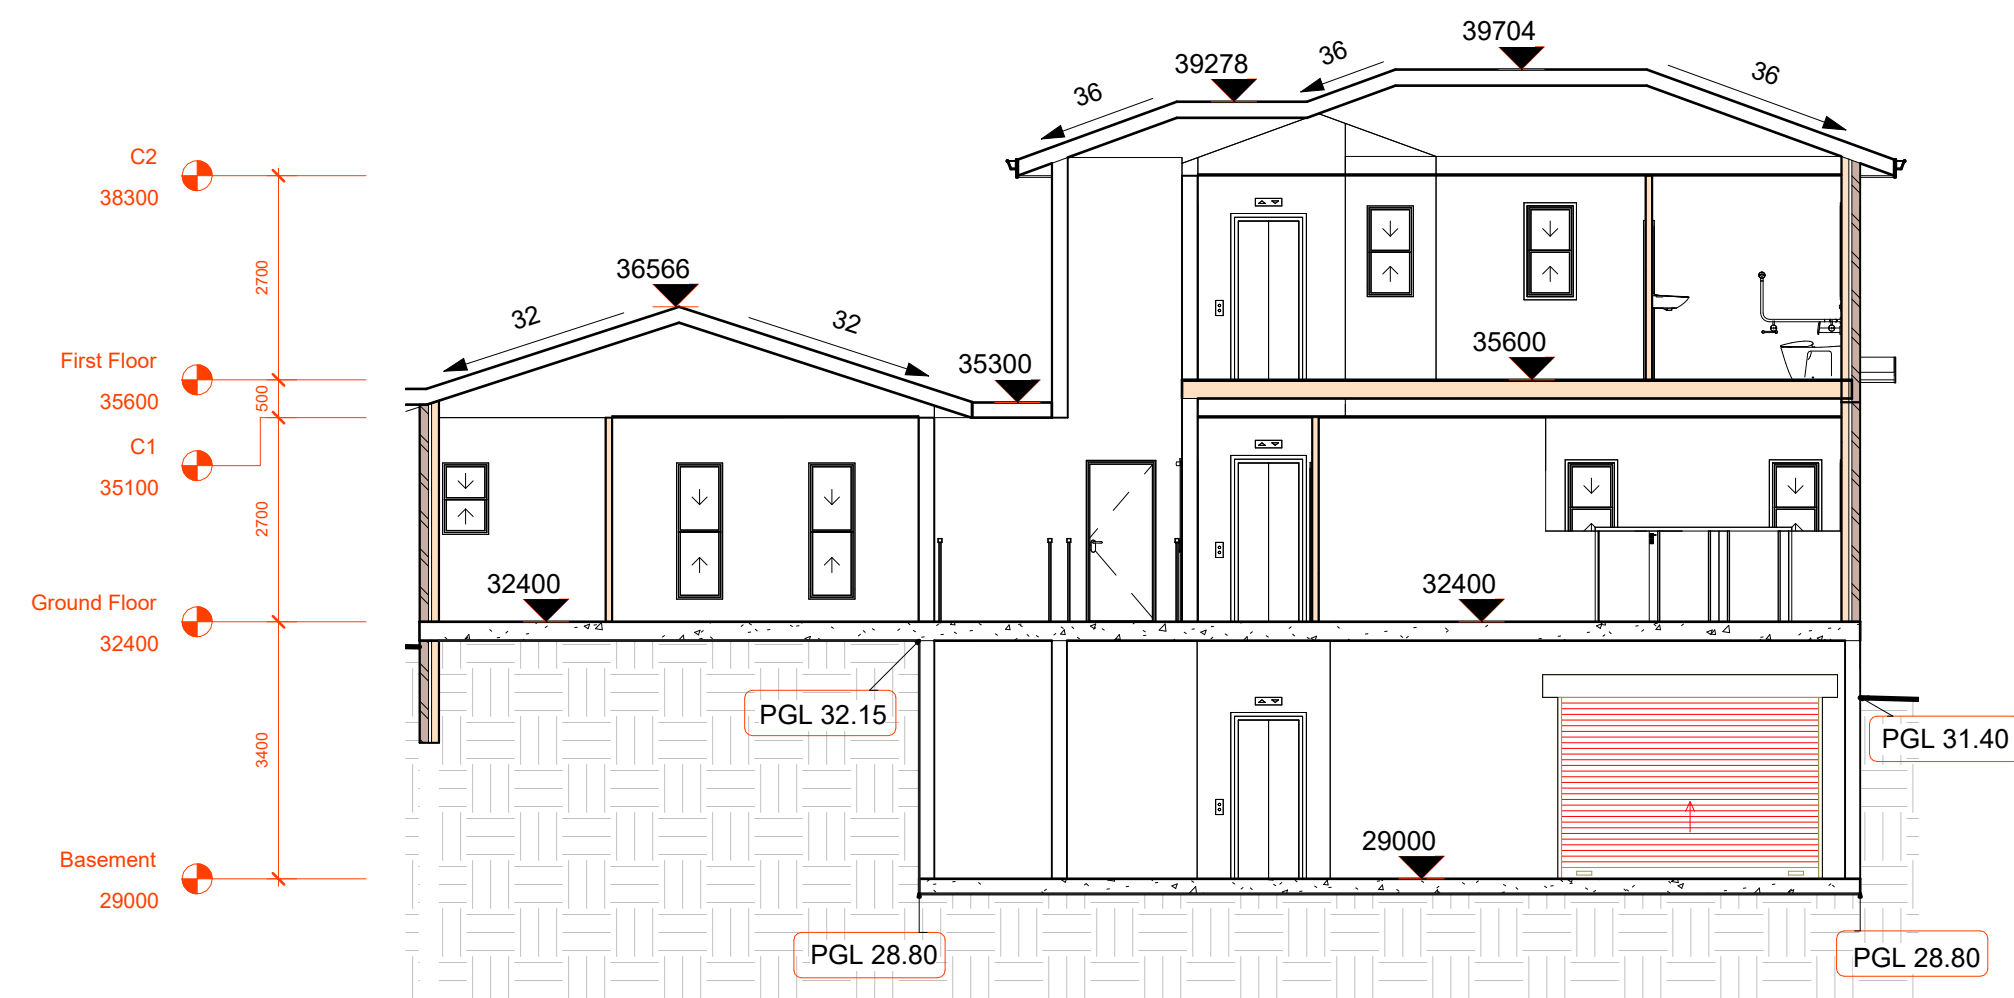

**3** Section 9  
SCALE: 1 : 100

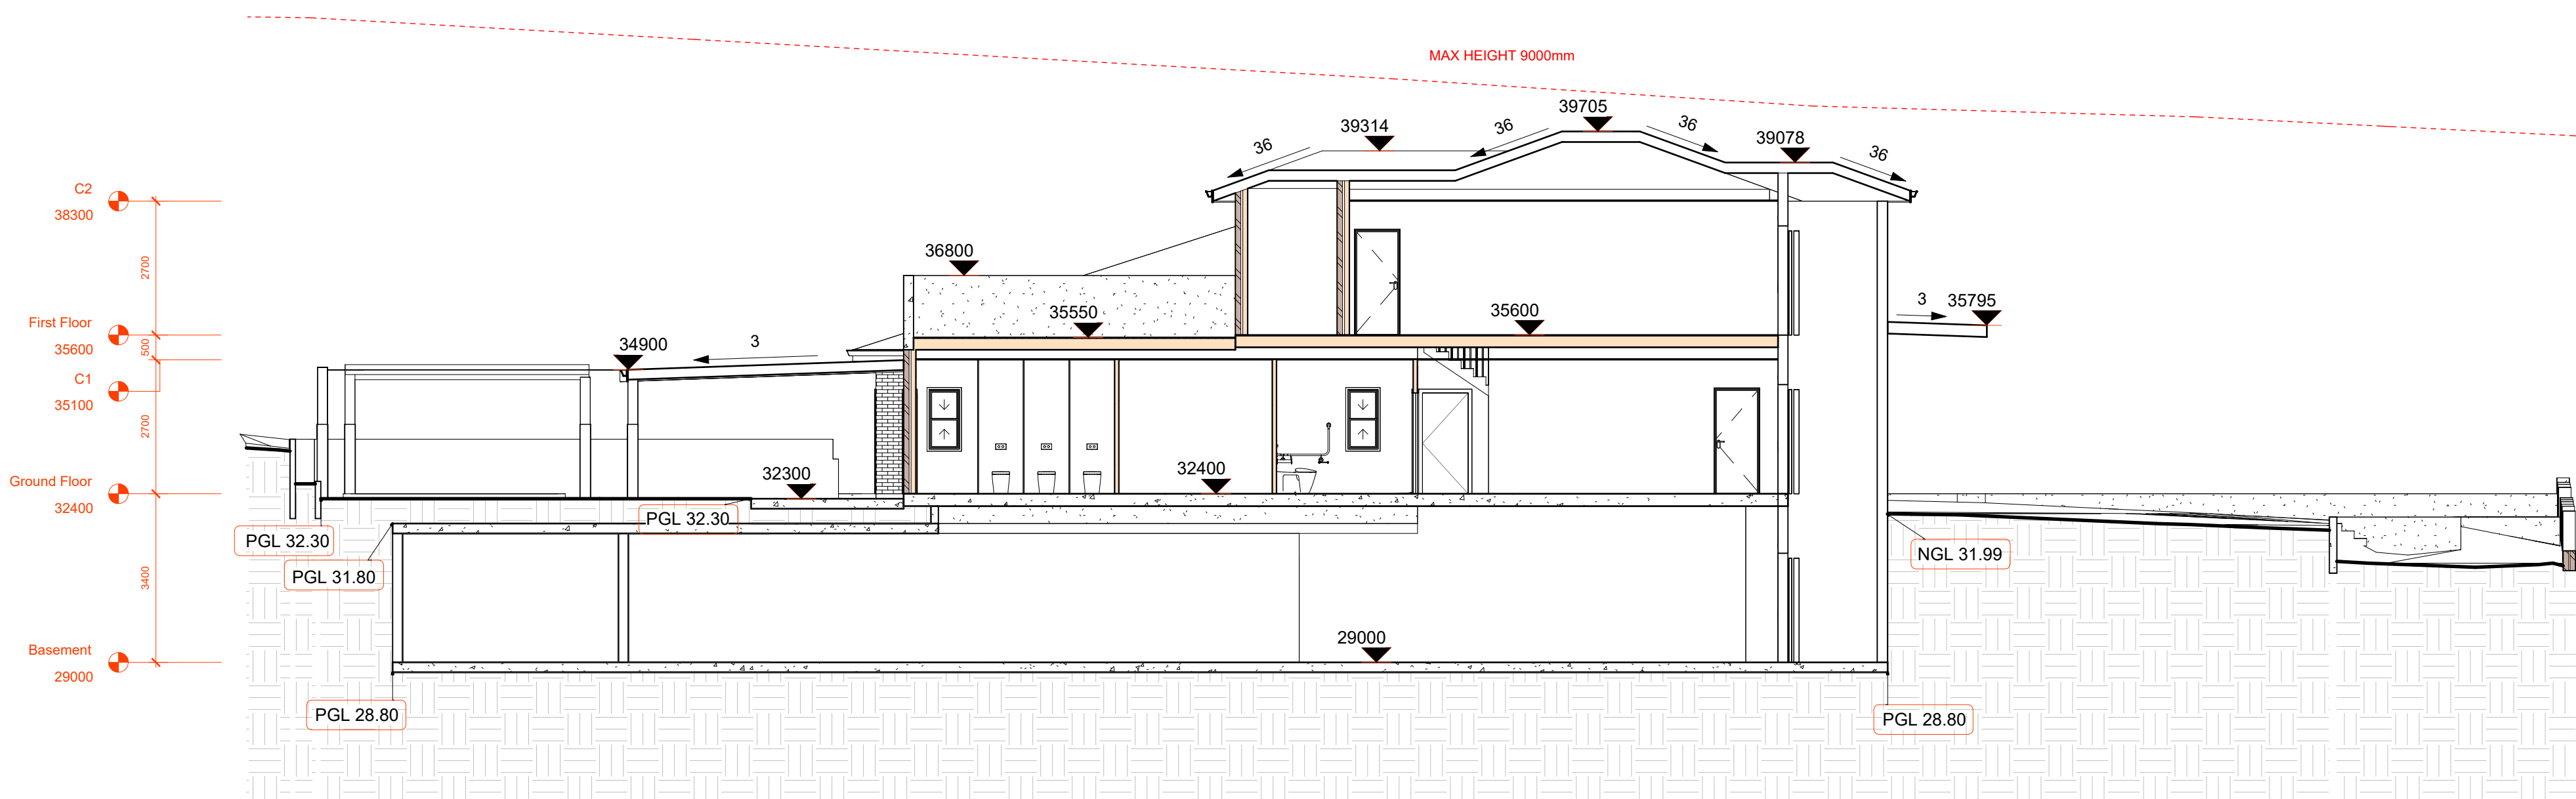

**2** Section 8  
SCALE: 1 : 100

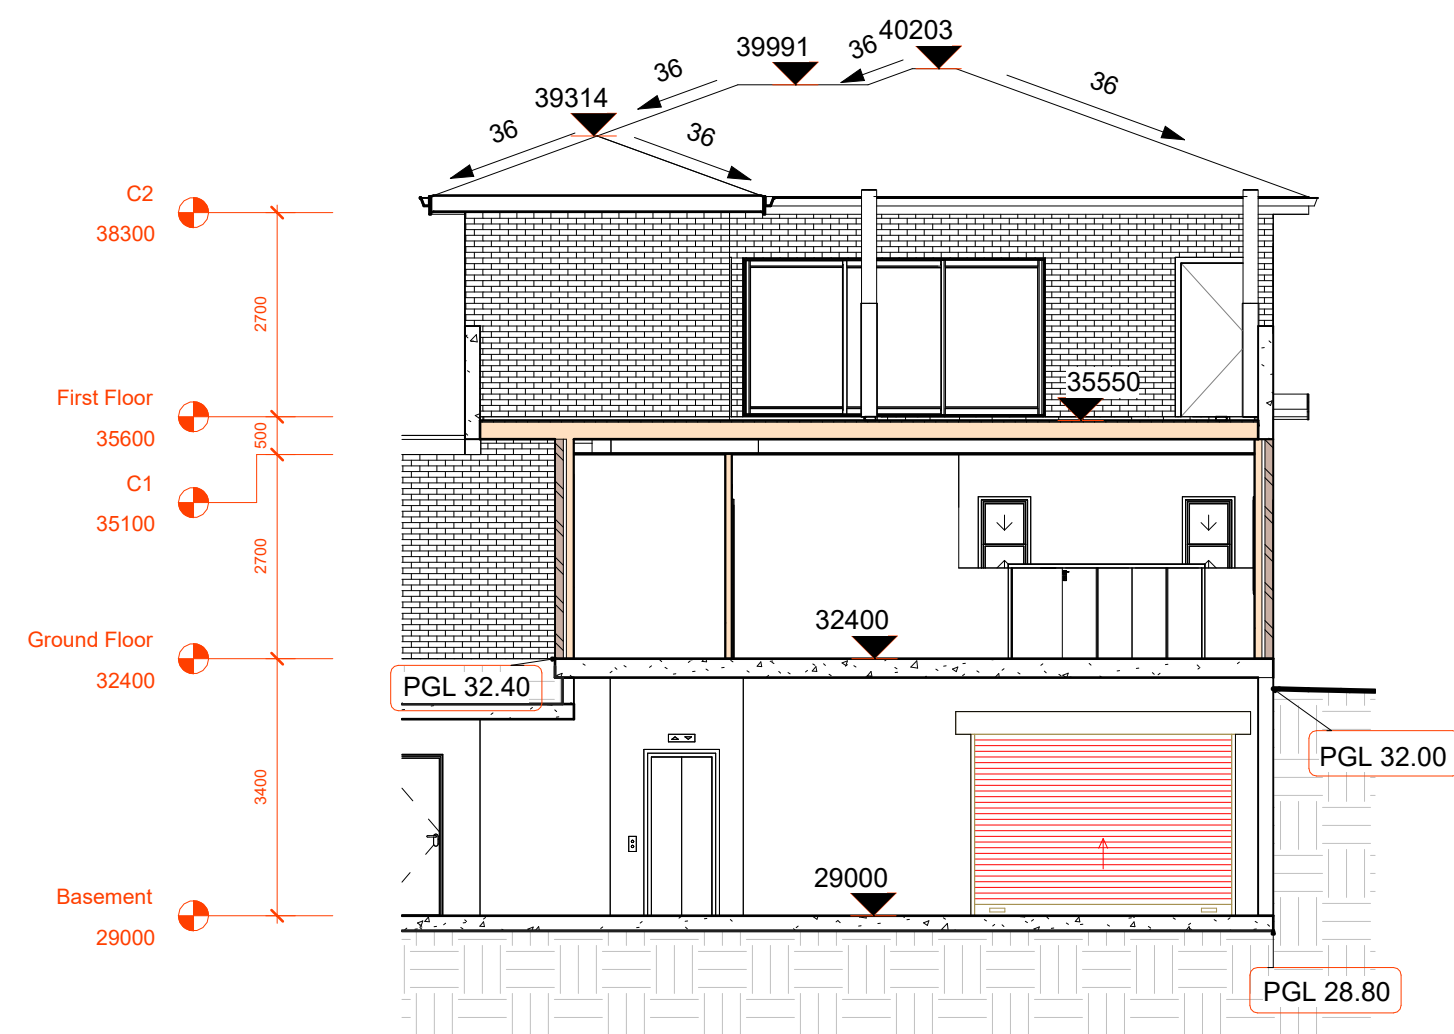

**4** Section 10  
SCALE: 1 : 100

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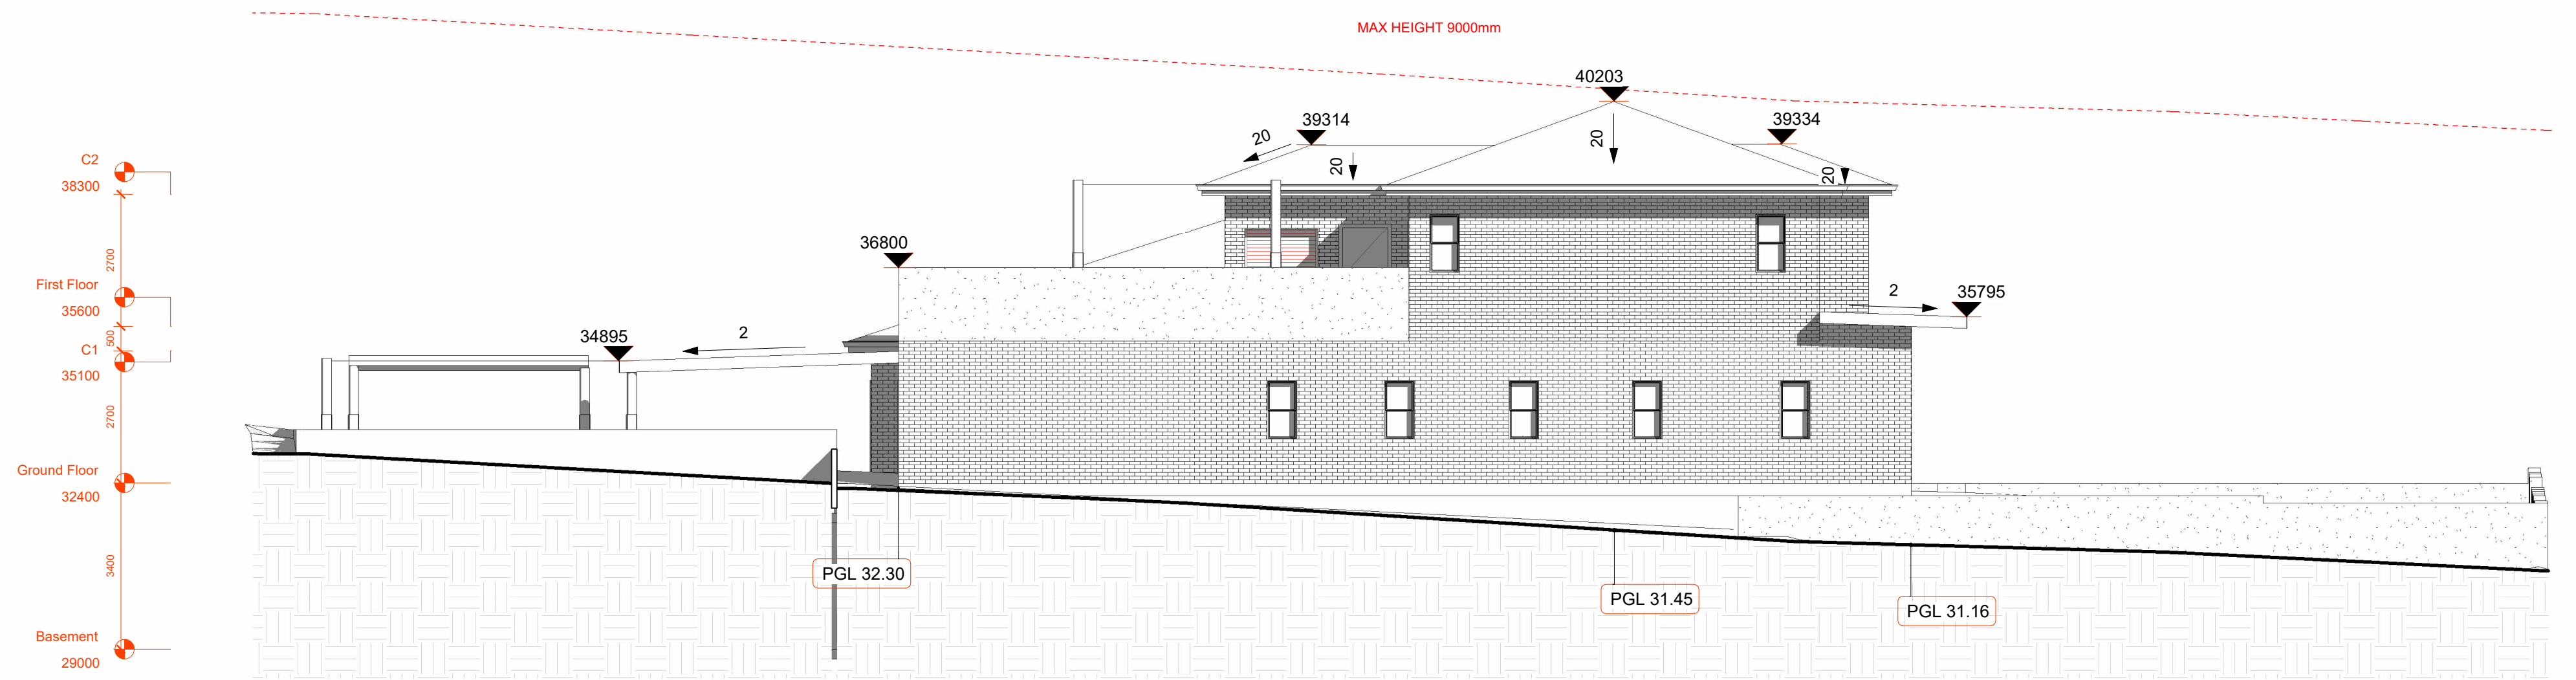
CONSTRUCTION OF A DOUBLE STORY CHILDCARE, FRONT  
FENCE AND BASEMENT CARPARK

42 - 44 NORFOLK ROAD, GREENACRE, 2190, NSW


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Job Number D2024/06	Drawing Number A05.01	Sheet scale A1
Scale 1 : 100	Page Total TBC	
Drawn By MA	Checked By AA	
Date 03/10/2024	Revision A	





1 West  
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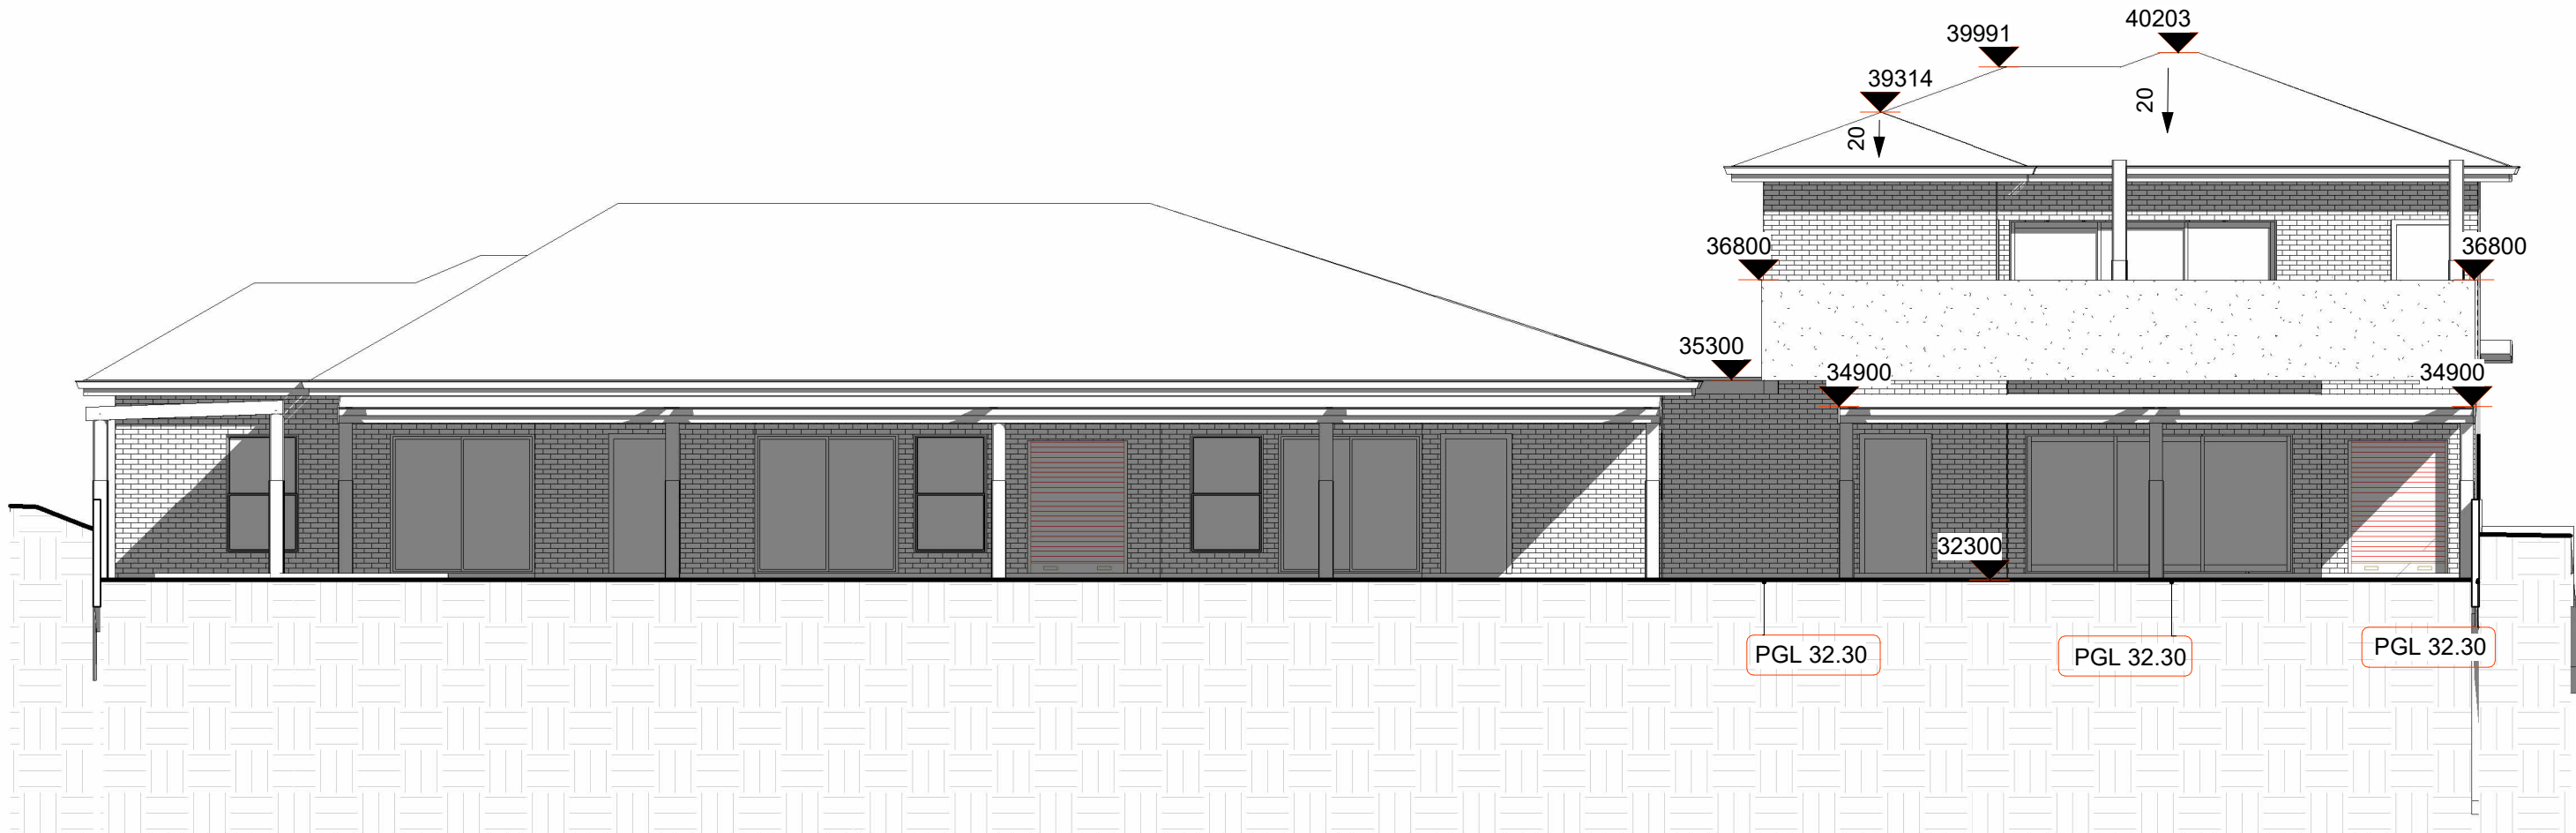
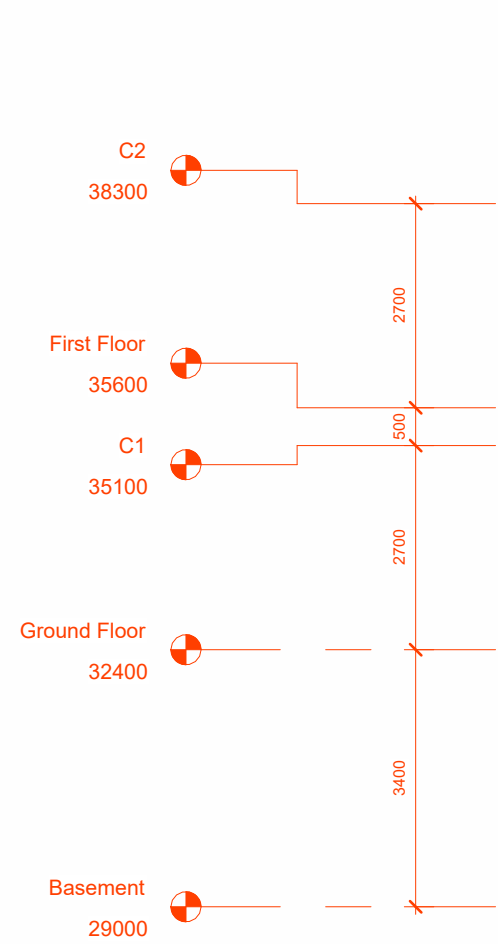


2 East  
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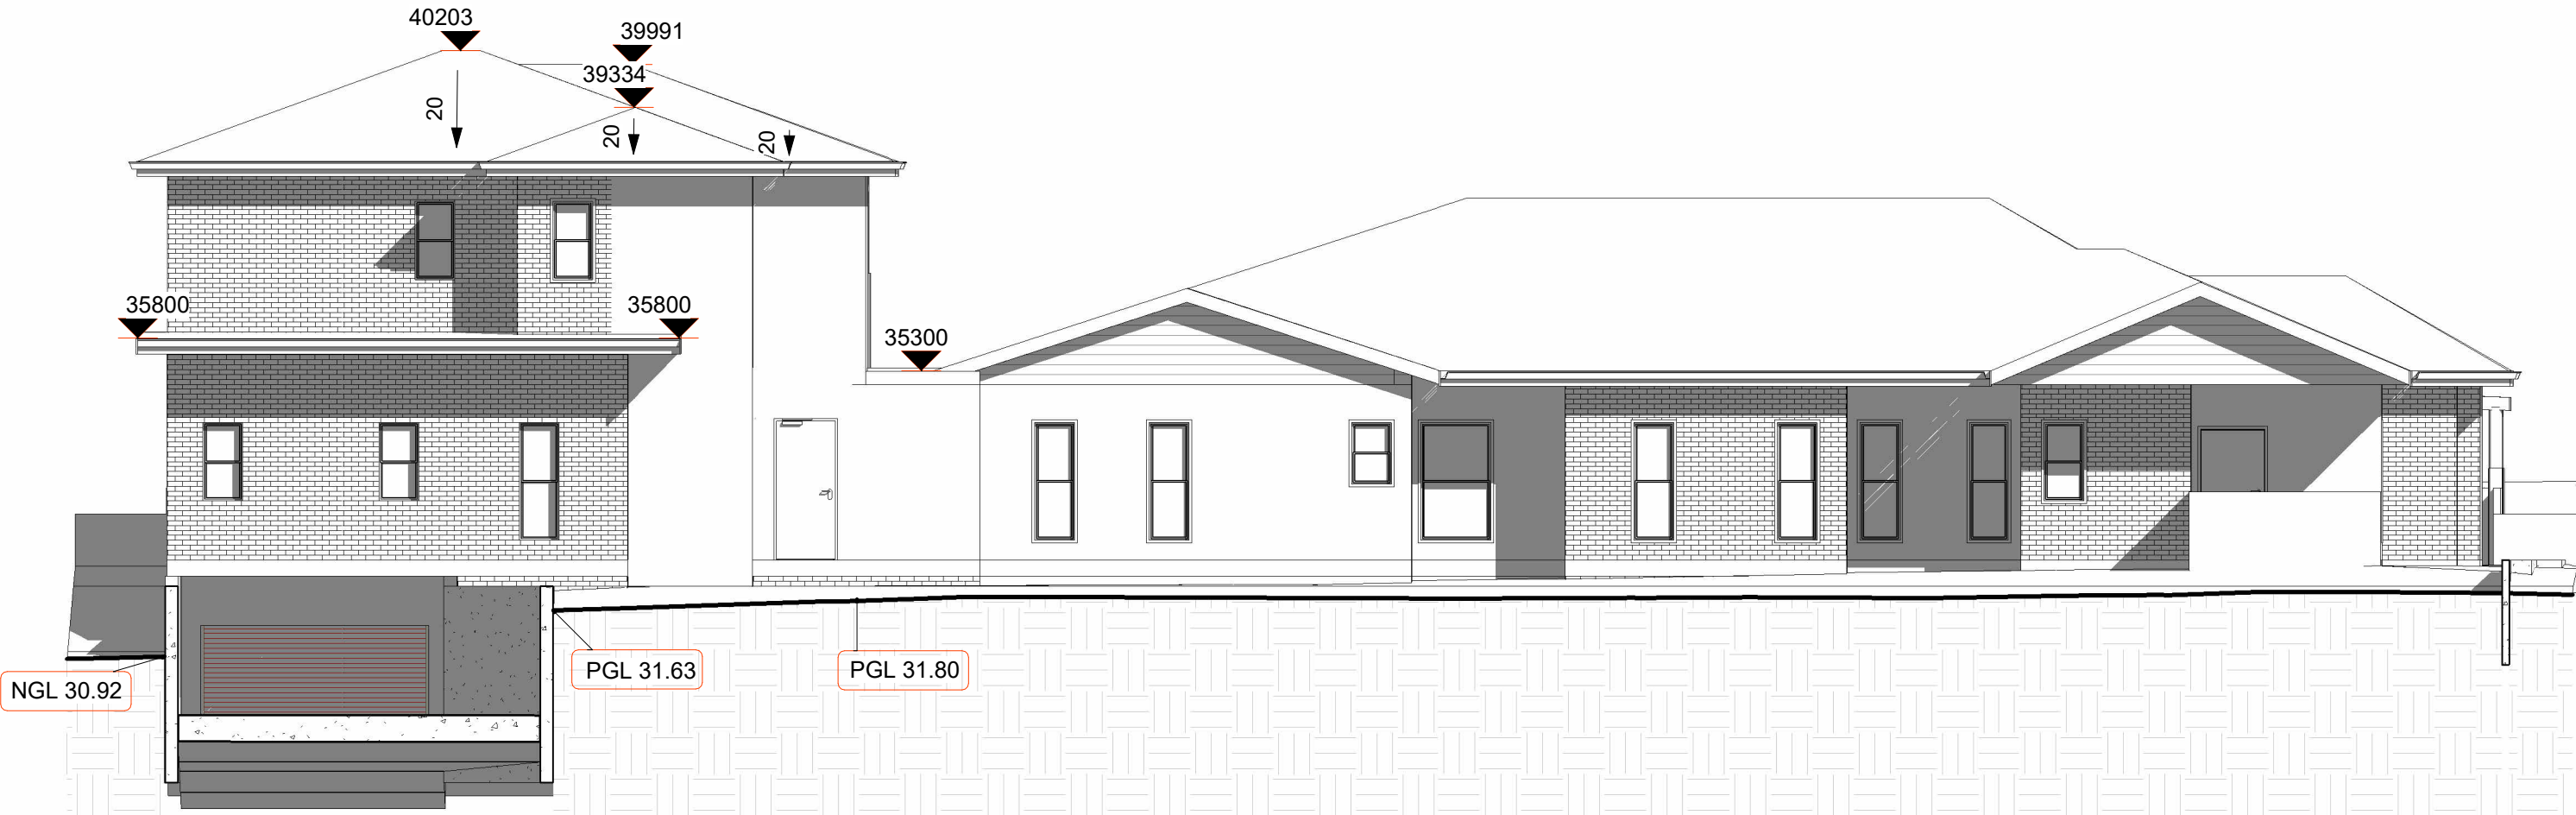
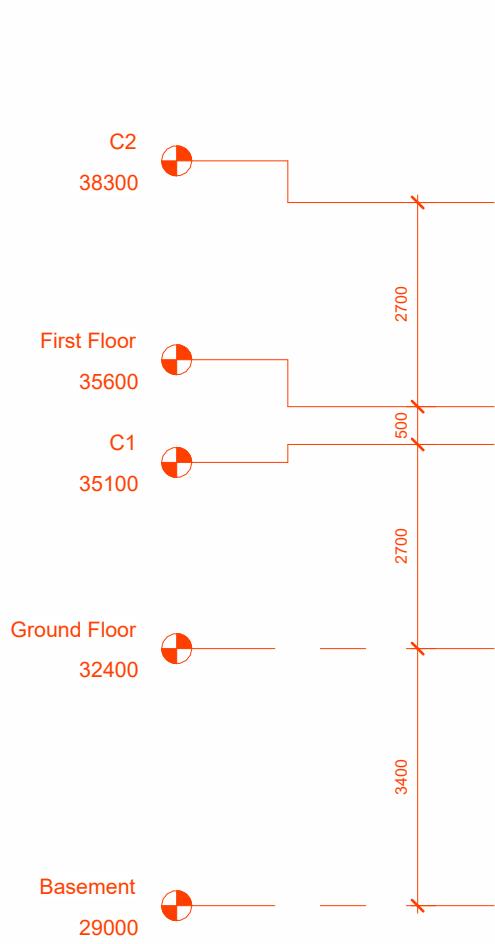
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							42 - 44 NORFOLK ROAD, GREENACRE, 2190, NSW	Scale 1 : 100	Page Total TBC	
							Elevations - 1	Drawn By MA	Checked By AA	
A	03/10/2024	DA DOCUMENTATION	MA					Date 03/10/2024	Revision A	
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1 North  
SCALE: 1 : 100

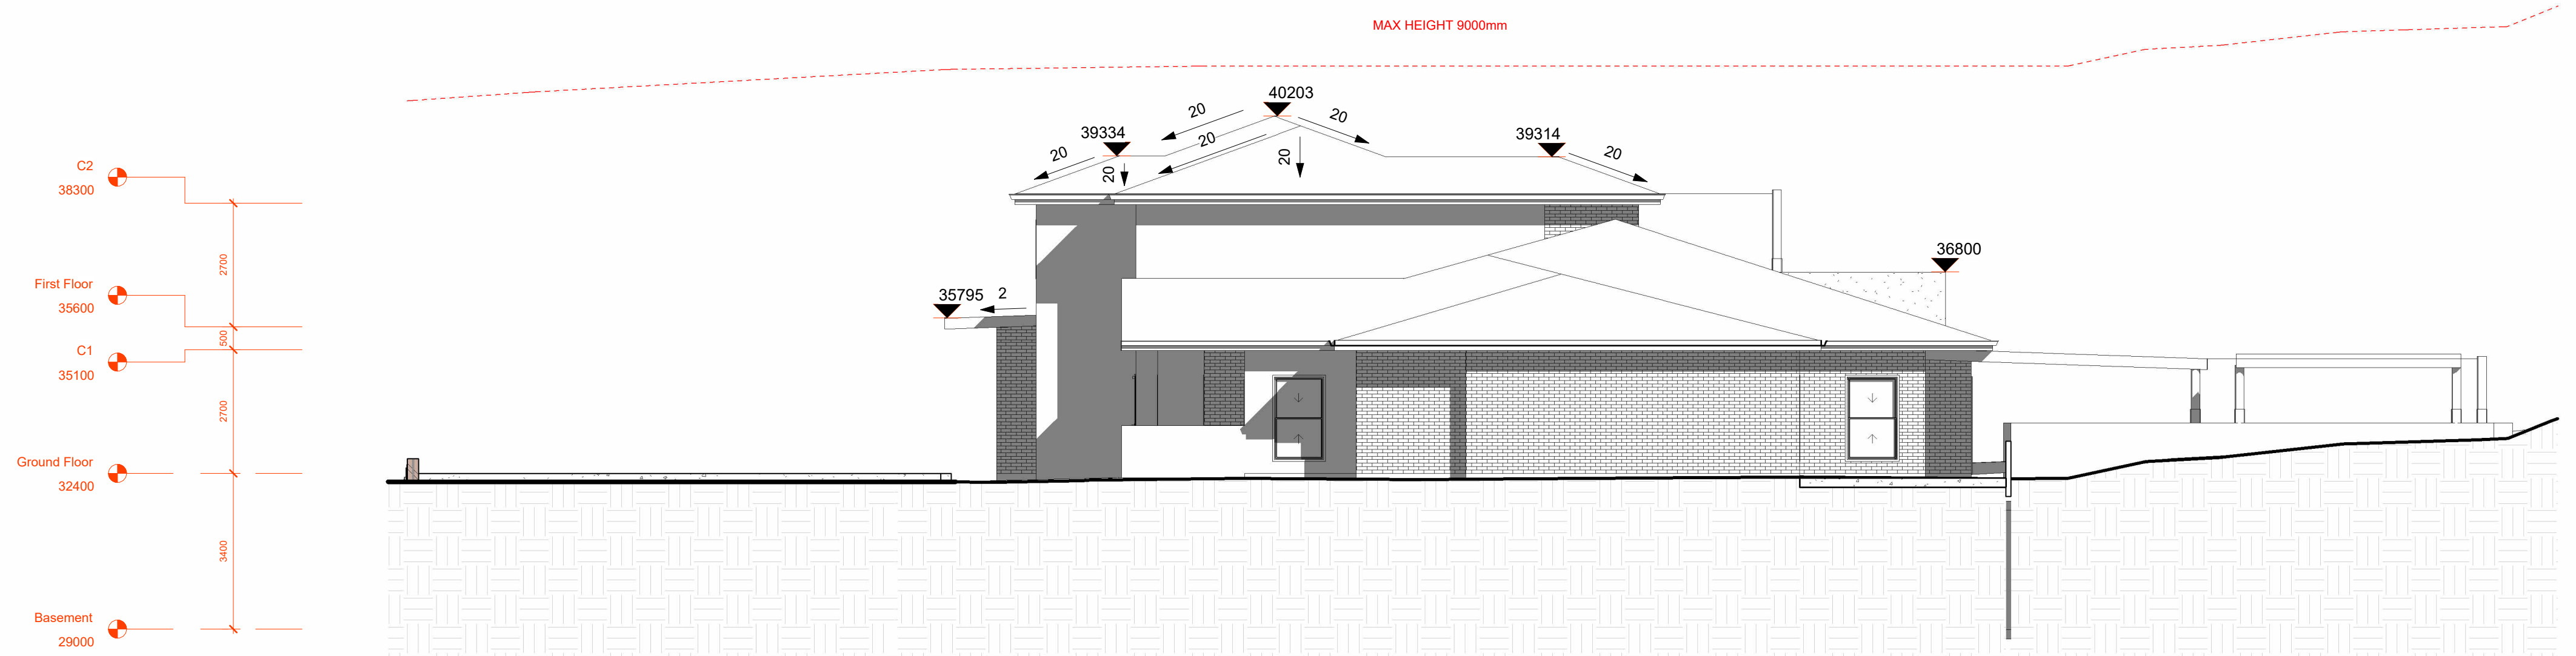


2 South  
SCALE: 1 : 100

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							42 - 44 NORFOLK ROAD, GREENACRE, 2190, NSW	Scale 1 : 100	Page Total TBC	
								Drawn By MA	Checked By AA	
							Elevations - 2	Date 03/10/2024	Revision A	
A	03/10/2024	DA DOCUMENTATION	MA							
REV	DATE	DESCRIPTION	BY							




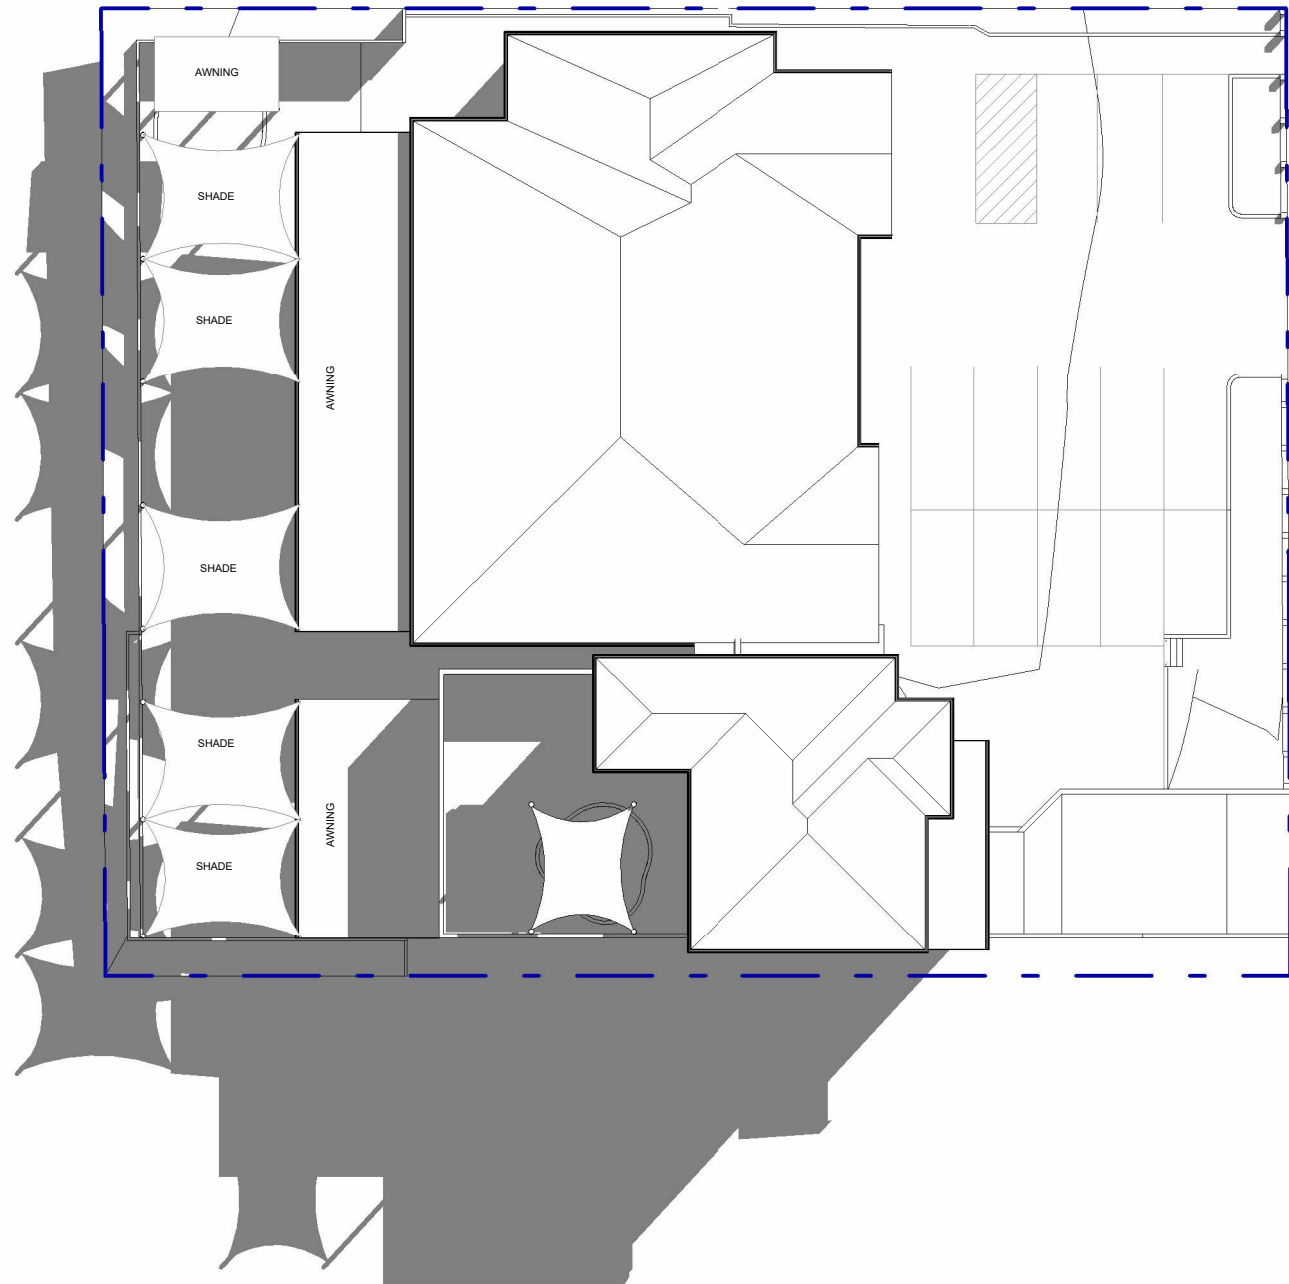

1 Summer - 9am  
SCALE: 1 : 300



2 Summer - 12pm  
SCALE: 1 : 300

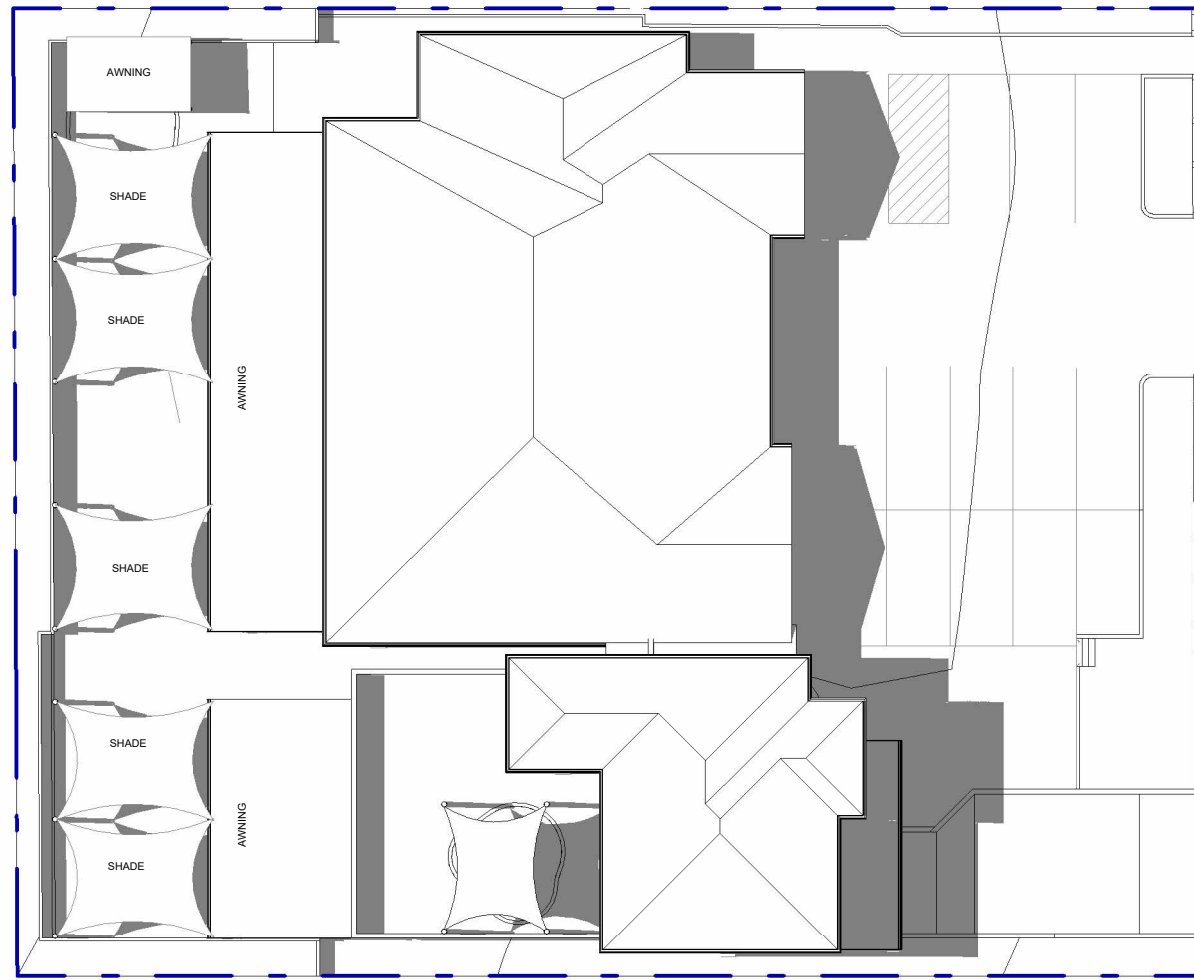


3 Winter - 3pm  
SCALE: 1 : 300



4 Winter - 9am  
SCALE: 1 : 300



5 Winter - 12pm  
SCALE: 1 : 300

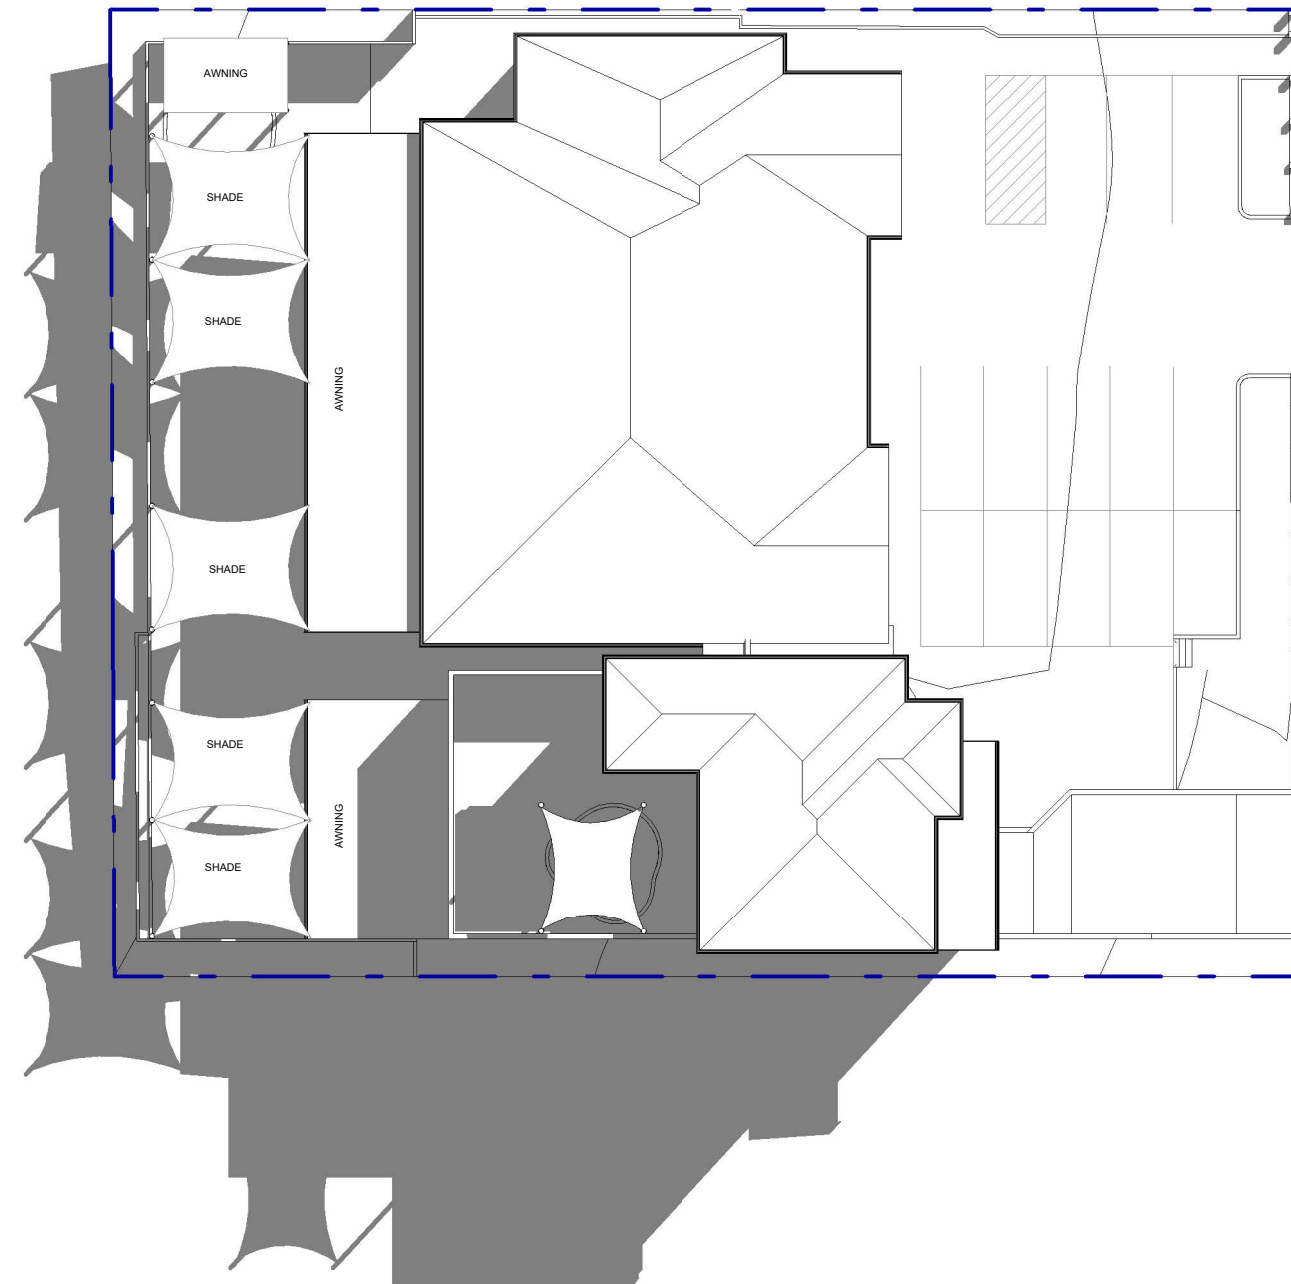

6 Summer - 3pm  
SCALE: 1 : 300

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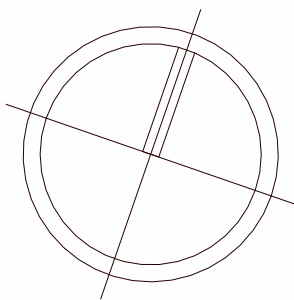


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CONSTRUCTION OF A DOUBLE STORY CHILDCARE, FRONT FENCE AND BASEMENT CARPARK
42 - 44 NORFOLK ROAD, GREENACRE, 2190, NSW
Shadow Diagram

Job Number D2024/06	Drawing Number A05.09	Sheet scale A1
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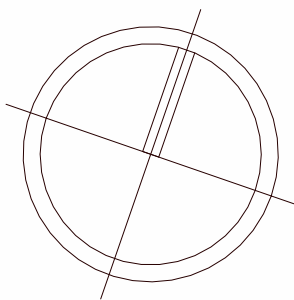


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CONSTRUCTION OF A DOUBLE STORY CHILDCARE, FRONT FENCE AND BASEMENT CARPARK
42 - 44 NORFOLK ROAD, GREENACRE, 2190, NSW
Schedule of Finish

Job Number D2024/06	Drawing Number A06.04	Sheet scale A1
Scale 1 : 50	Page Total TBC	
Drawn By MA	Checked By AA	
Date 03/10/2024	Revision A	